


STATE MAP
NOT TO SCALE

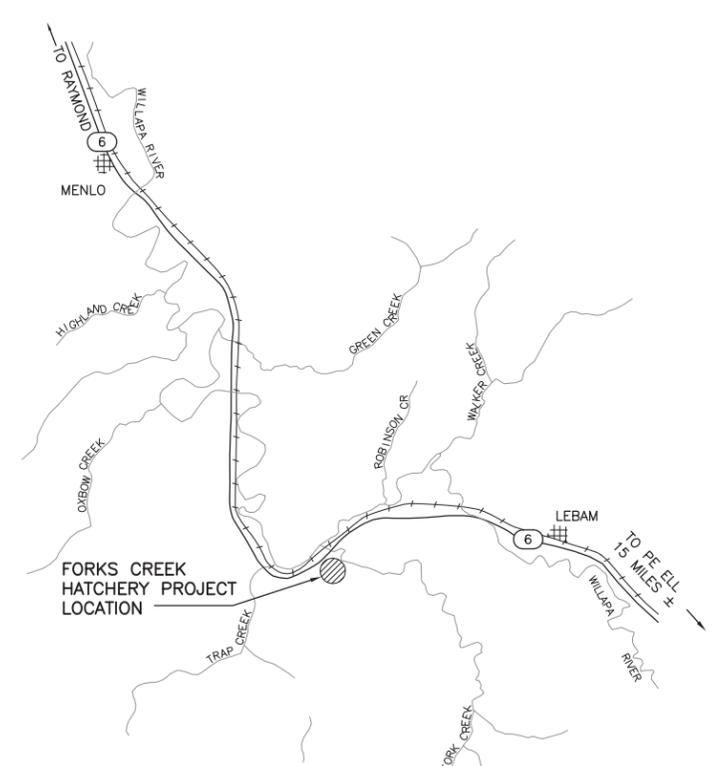

VICINITY MAP
NOT TO SCALE

ELEVATION DATUM
N.A.V.D. 1988 DATUM
BENCHMARK:
W.S.D.O.T. DESIGNATION: S 64 MONUMENT ID: 5591
BRASS DISK SET IN TOP OF A SQ. CONCRETE
MONUMENT, SET LEVEL WITH THE GROUND SURFACE.
ELEVATION = 171.532
N 463680.175
E 863754.834

BASIS OF BEARINGS
WASHINGTON STATE PLANE NORTH ZONE (NAD 83)
BASIS OF POSITION: W.S.D.O.T.
DESIGNATION: S 64 MONUMENT ID: 5591
N 463680.175
E 863754.834
AND
DESIGNATION: T 64 MONUMENT ID: 5592
N 461555.271
E 857746.592

PROPERTY INFORMATION	
ADDRESS:	1986 STATE ROUTE 6 RAYMOND, WA 98612
COUNTY:	PACIFIC
PARCEL NUMBER:	12070613001
SECTION:	6
TOWNSHIP:	12 N
RANGE:	7 W

EXISTING SITE PLAN
SCALE: 1" = 60'

PERMIT DRAWINGS



WASHINGTON STATE
DEPARTMENT OF FISH AND WILDLIFE


SYM	DATE	REVISION DESCRIPTION	BY
APPROVED AND RELEASED FOR CONSTRUCTION			
CHIEF ENGINEER		DATE:	
PROGRAM		DATE:	

DESIGNED BY	
CHECKED BY	
DRAWN BY	
DATE	October 31, 2012

0 — 1" BAR MEASURES ONE INCH ON ORIGINAL DRAWINGS

FORKS CREEK HATCHERY
ADULT HOLDING FACILITY
EXISTING SITE PLAN,
STATE MAP AND VICINITY MAP

PROJECT NO.	
SHEET	OF
1	6

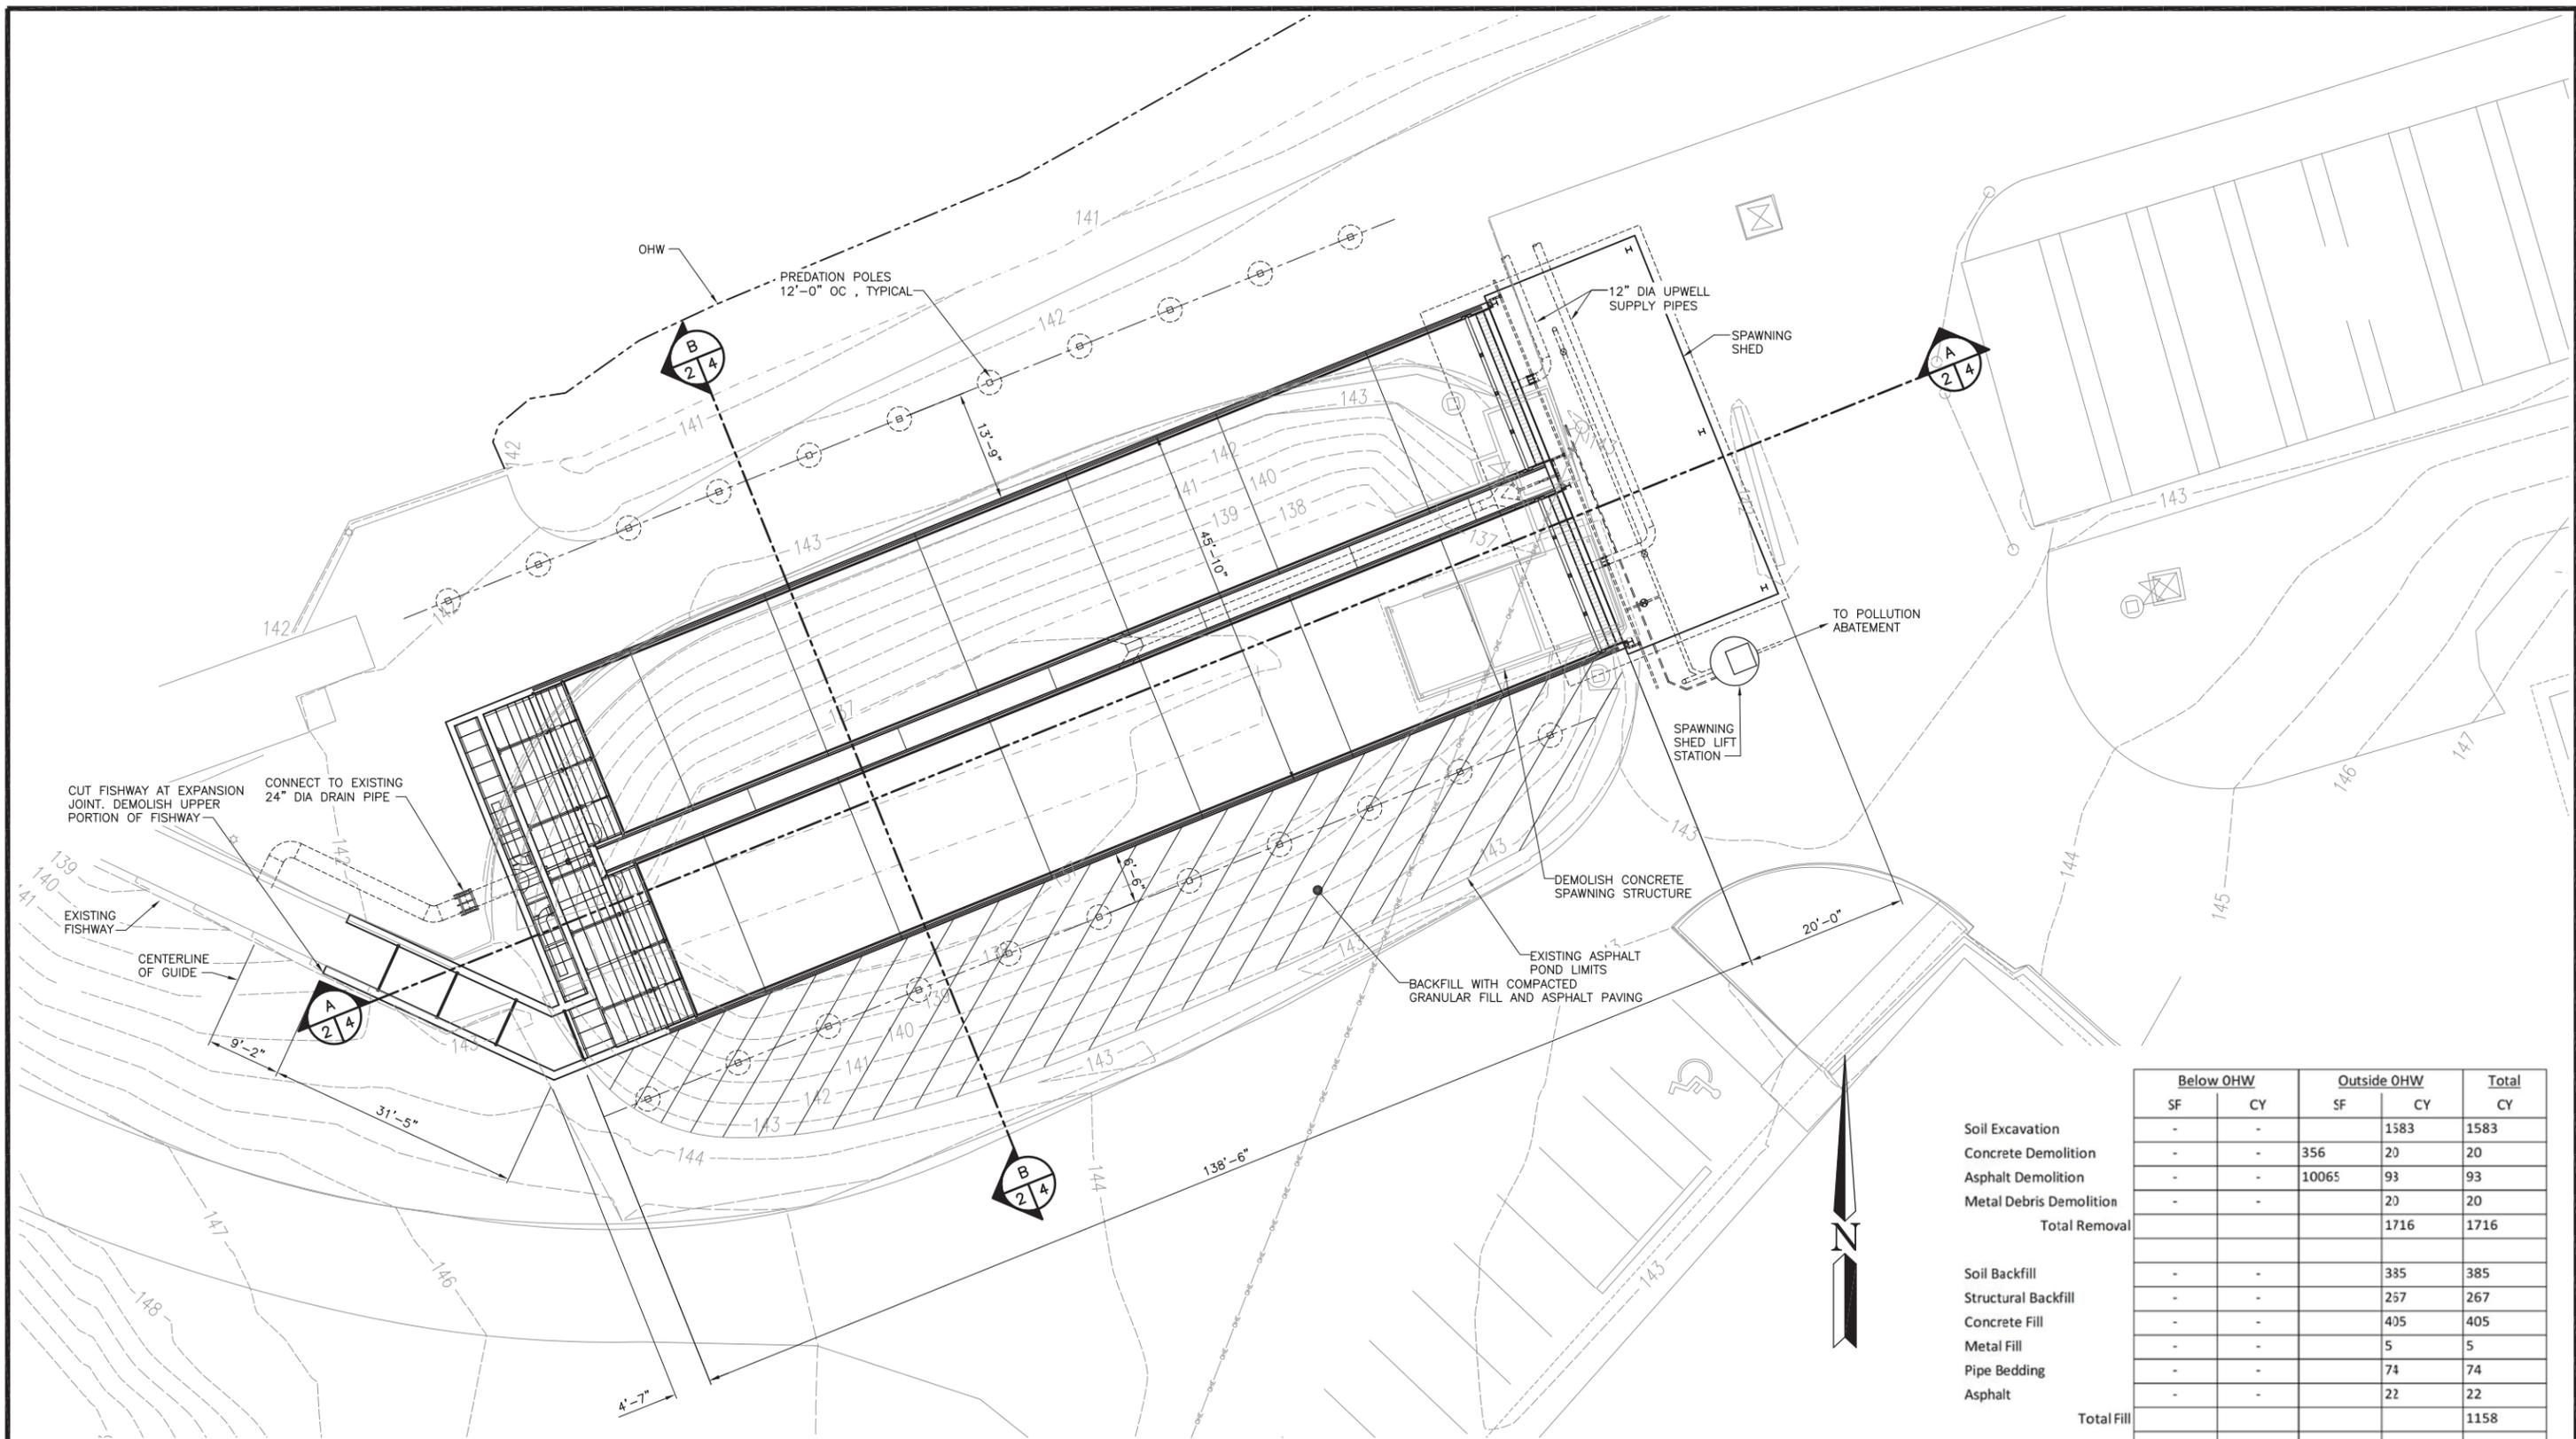

SITE PLAN
SCALE: 1" = 20'

	Below OHW		Outside OHW		Total CY
	SF	CY	SF	CY	
Soil Excavation	-	-	1383	1583	1583
Concrete Demolition	-	-	356	20	20
Asphalt Demolition	-	-	10065	93	93
Metal Debris Demolition	-	-	20	20	20
Total Removal			1716	1716	1716
Soil Backfill	-	-	335	385	385
Structural Backfill	-	-	257	267	267
Concrete Fill	-	-	405	405	405
Metal Fill	-	-	5	5	5
Pipe Bedding	-	-	74	74	74
Asphalt	-	-	22	22	22
Total Fill					1158
Total Disturbed Area			10421		

PERMIT DRAWINGS



WASHINGTON STATE
DEPARTMENT OF FISH AND WILDLIFE

SYM	DATE	REVISION DESCRIPTION	BY
APPROVED AND RELEASED FOR CONSTRUCTION			
CHIEF ENGINEER	DATE:	DESIGNED BY	CHECKED BY
PROGRAM	DATE:	DRAWN BY	DATE: October 31, 2012


0 — 1"
BAR MEASURES
ONE INCH ON
ORIGINAL DRAWINGS

FORKS CREEK HATCHERY
ADULT HOLDING FACILITY

SITE PLAN

PROJECT NO.

SHEET 2 OF 6

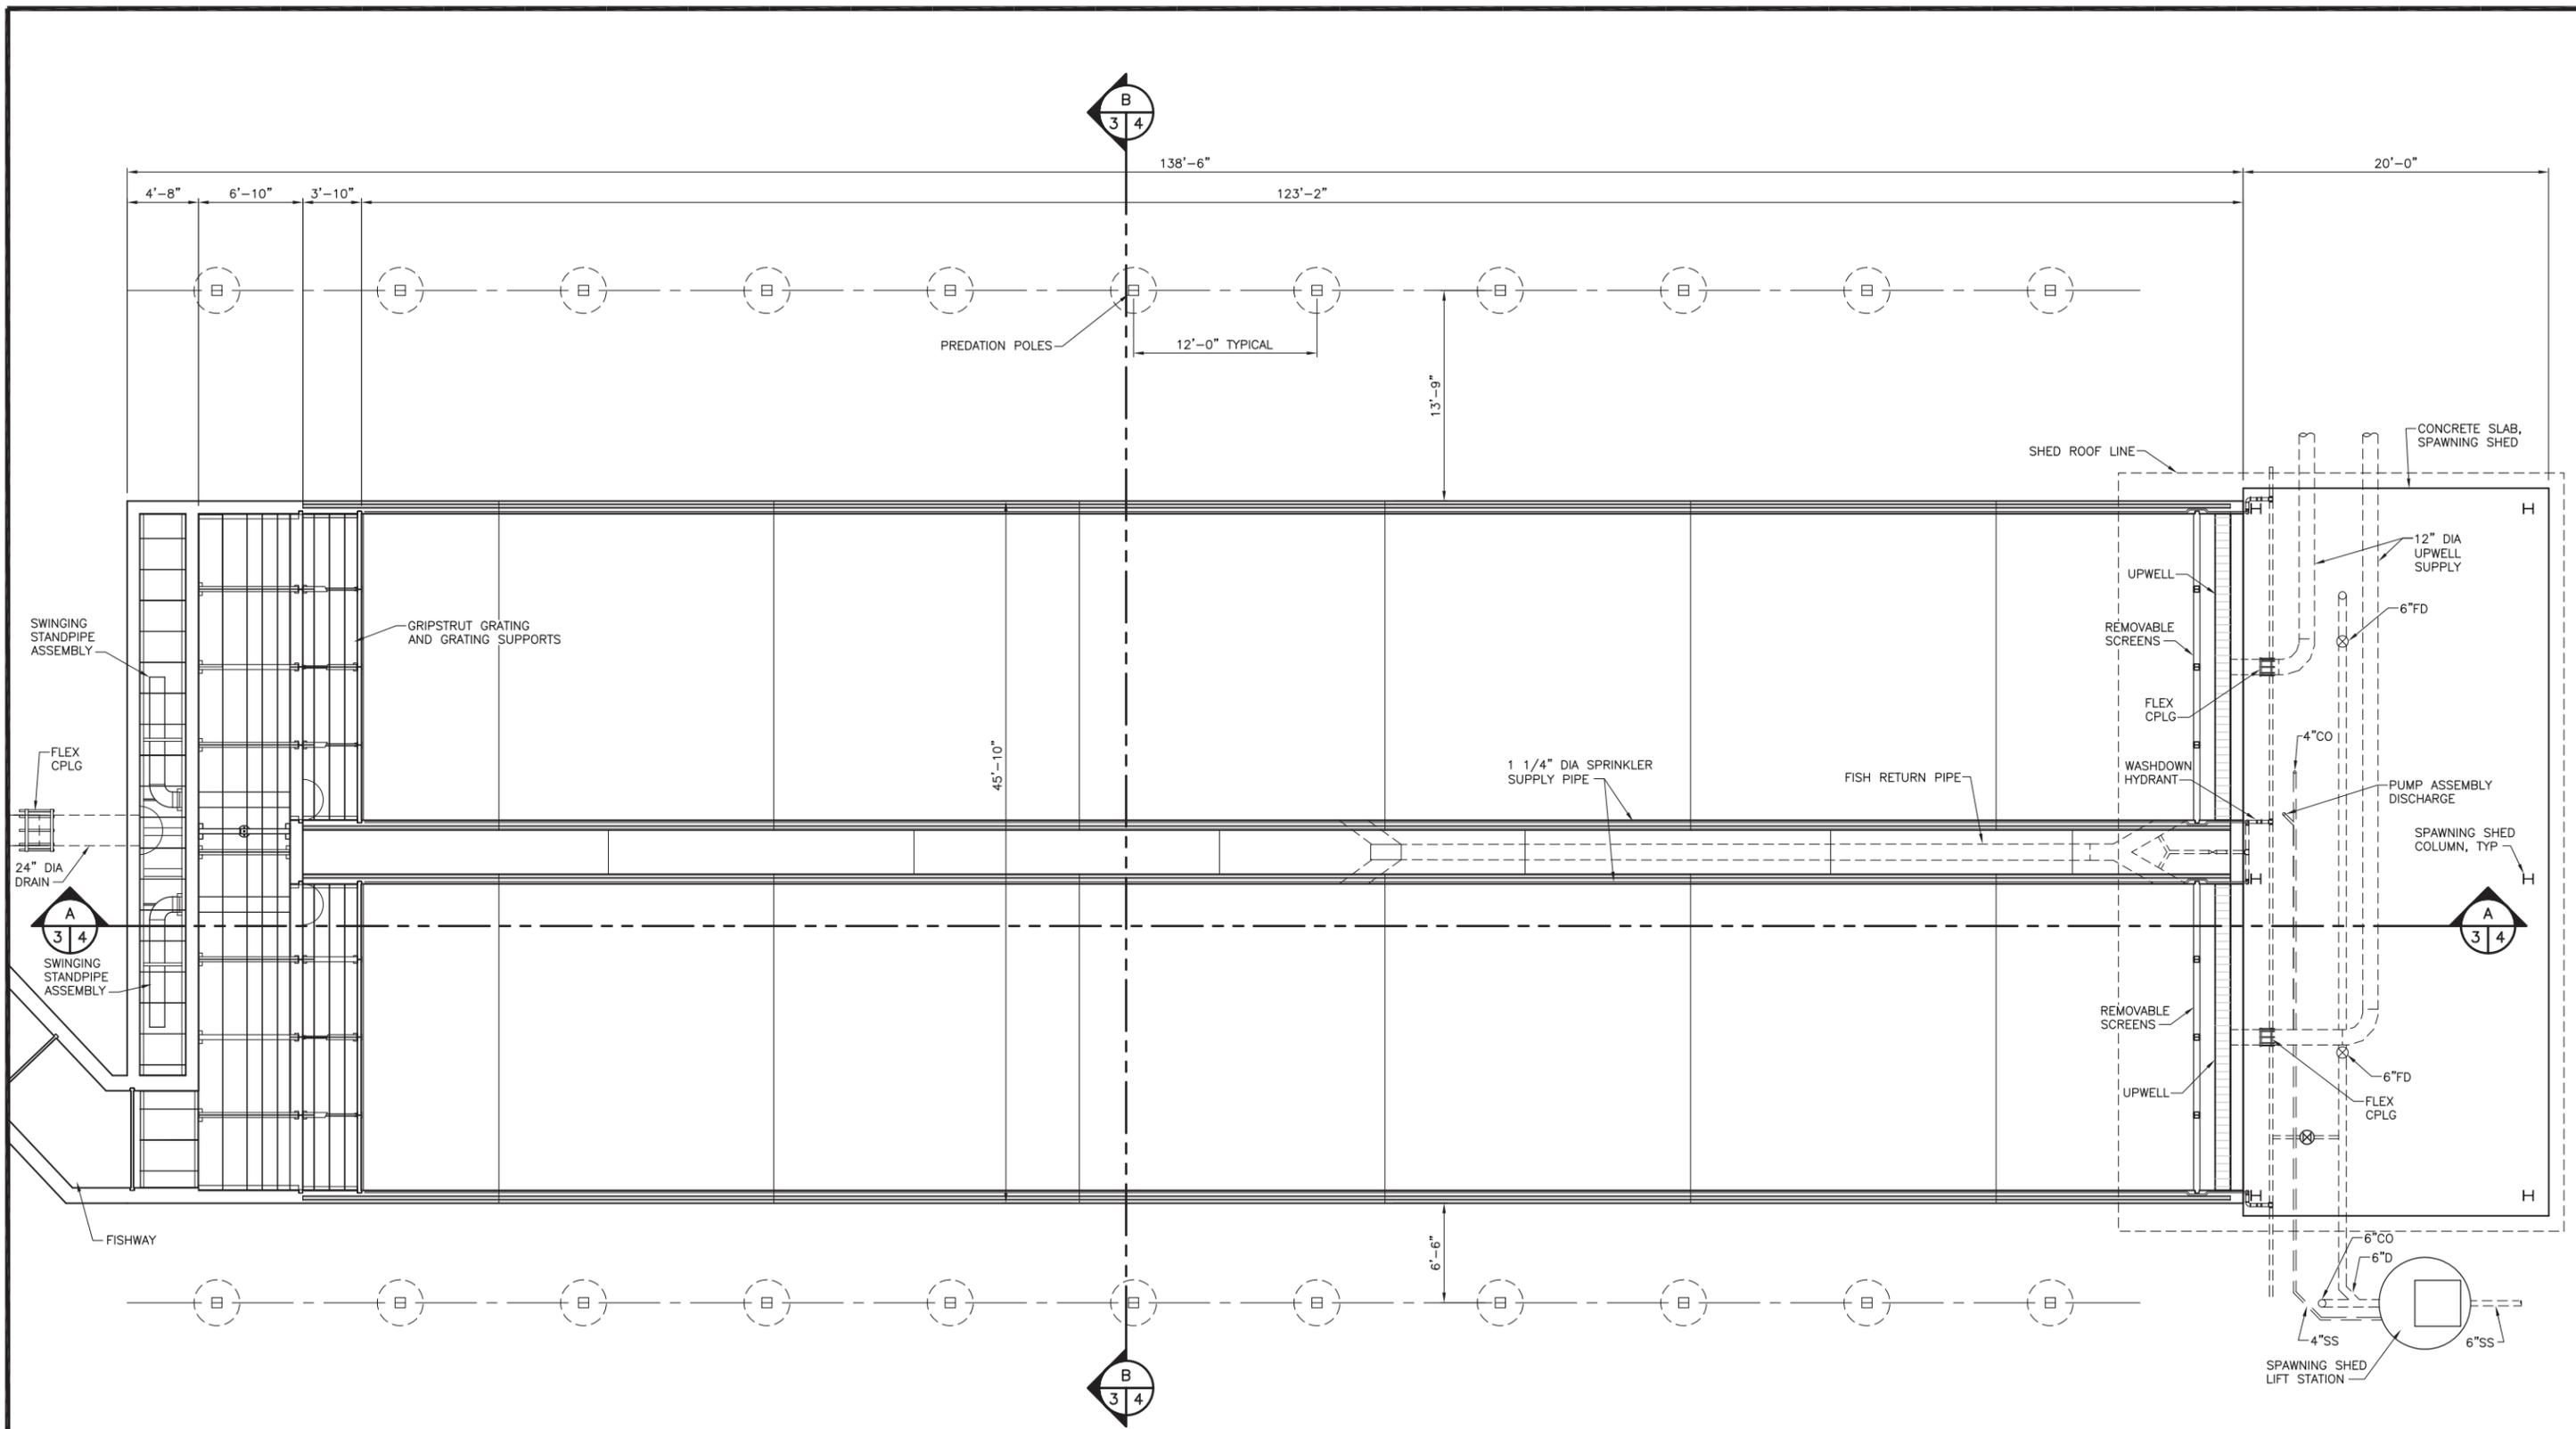

ADULT HOLDING FACILITY PLAN
 SCALE: 3/32" = 1'-0"

PERMIT DRAWINGS





WASHINGTON STATE
DEPARTMENT OF FISH AND WILDLIFE

SYM	DATE	REVISION DESCRIPTION	BY
APPROVED AND RELEASED FOR CONSTRUCTION			
CHIEF ENGINEER		DATE:	DESIGNED BY
PROGRAM		DATE:	CHECKED BY
			DRAWN BY
			DATE: October 31, 2012

0 — 1"
 BAR MEASURES
 ONE INCH ON
 ORIGINAL DRAWINGS

FORKS CREEK HATCHERY
ADULT HOLDING FACILITY
 PLAN

PROJECT NO.
 SHEET 3 OF 6

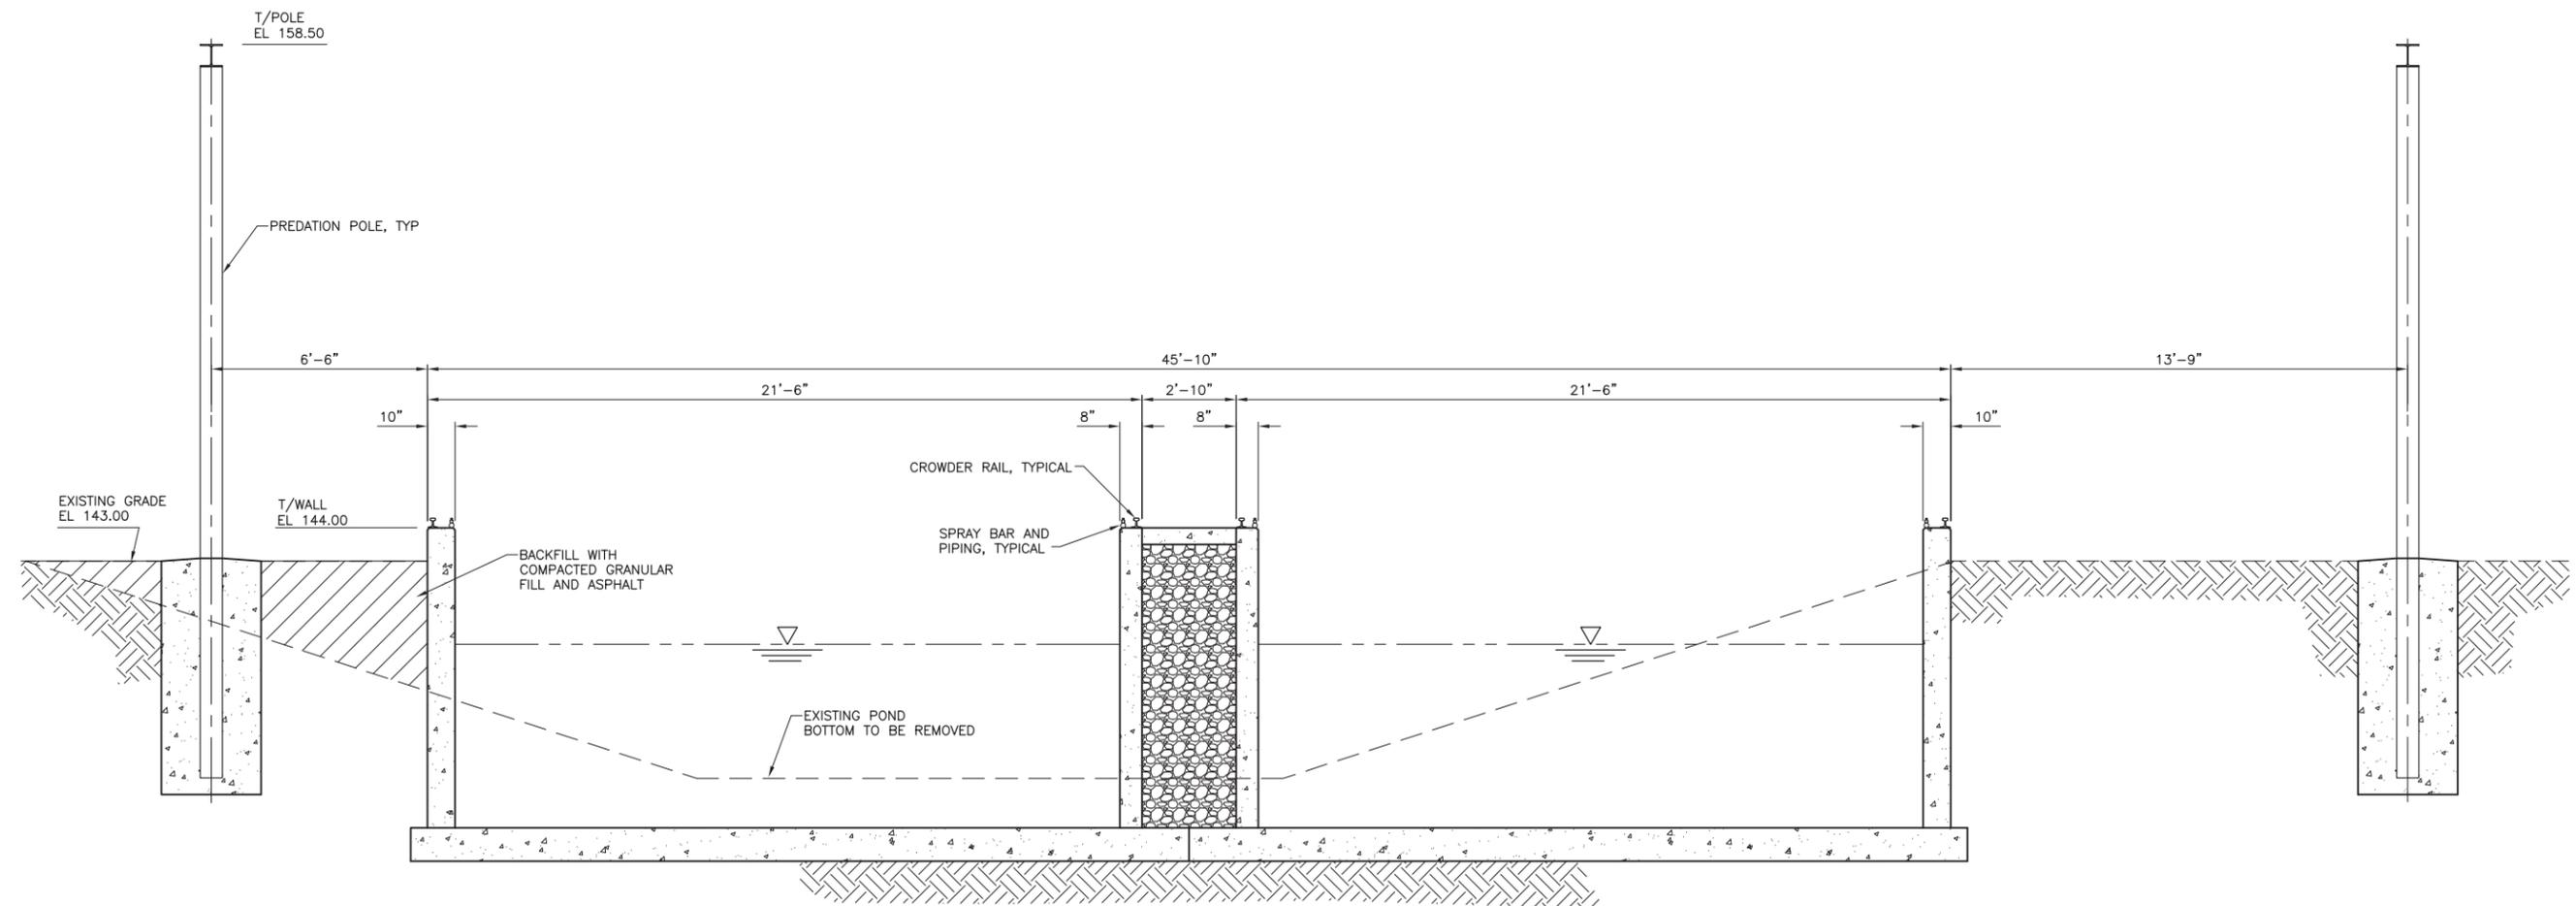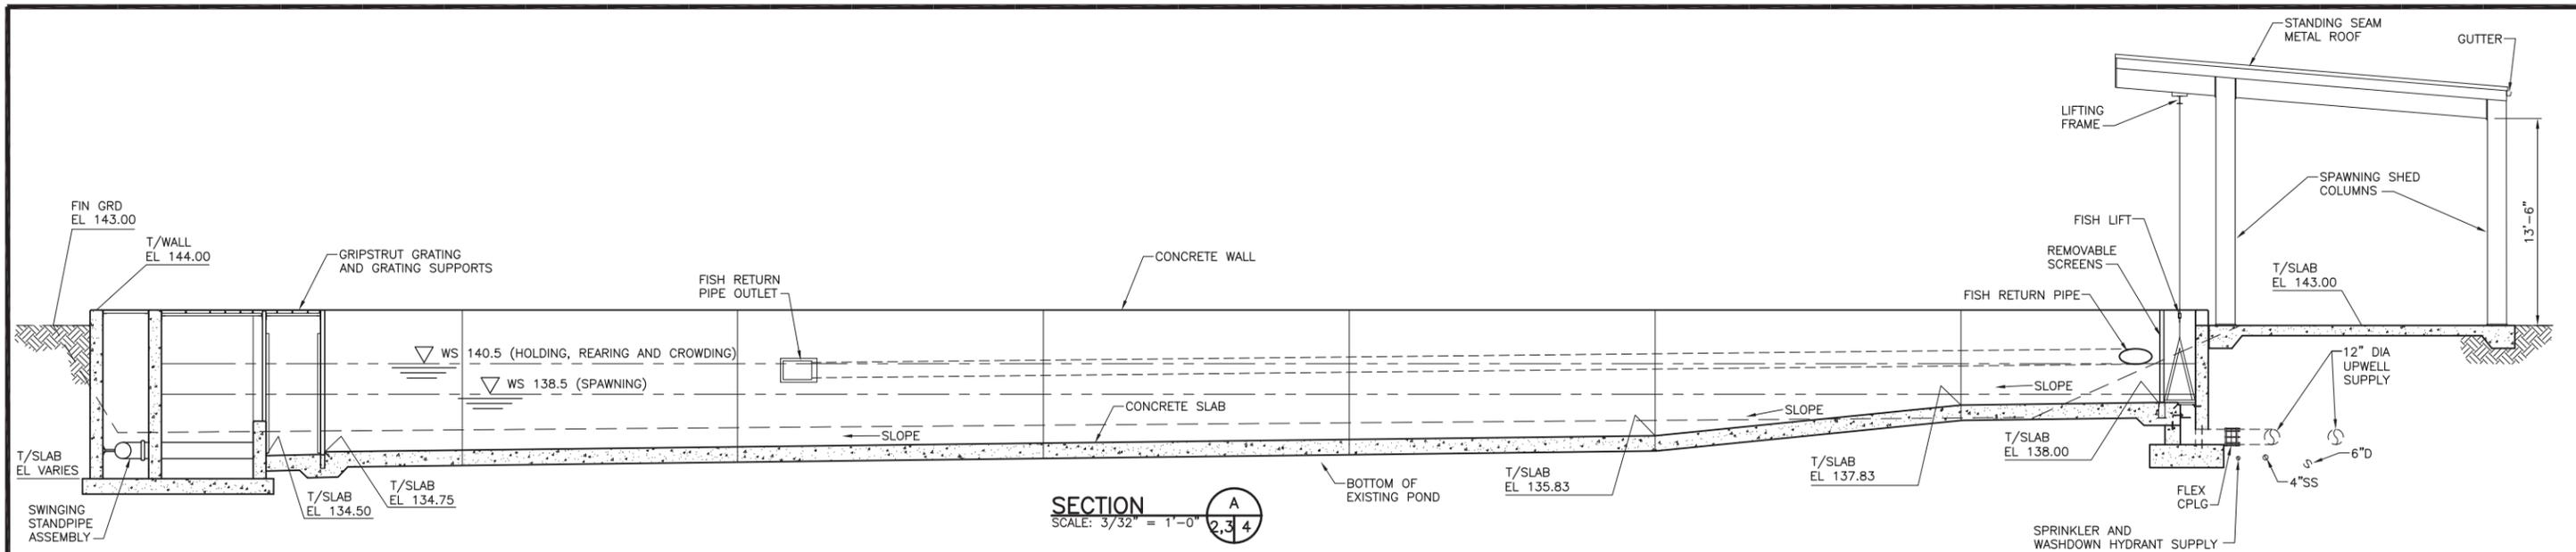

PERMIT DRAWINGS



WASHINGTON STATE
DEPARTMENT OF FISH AND WILDLIFE

SECTION B
SCALE: 3/16" = 1'-0"

SYM	DATE	REVISION DESCRIPTION	BY
APPROVED AND RELEASED FOR CONSTRUCTION			
CHIEF ENGINEER		DATE:	DESIGNED BY
PROGRAM		DATE:	CHECKED BY
			DRAWN BY
			DATE: October 31, 2012


0 — 1"
BAR MEASURES
ONE INCH ON
ORIGINAL DRAWINGS

FORKS CREEK HATCHERY
ADULT HOLDING FACILITY

SECTIONS

PROJECT NO.

SHEET 4 OF 6

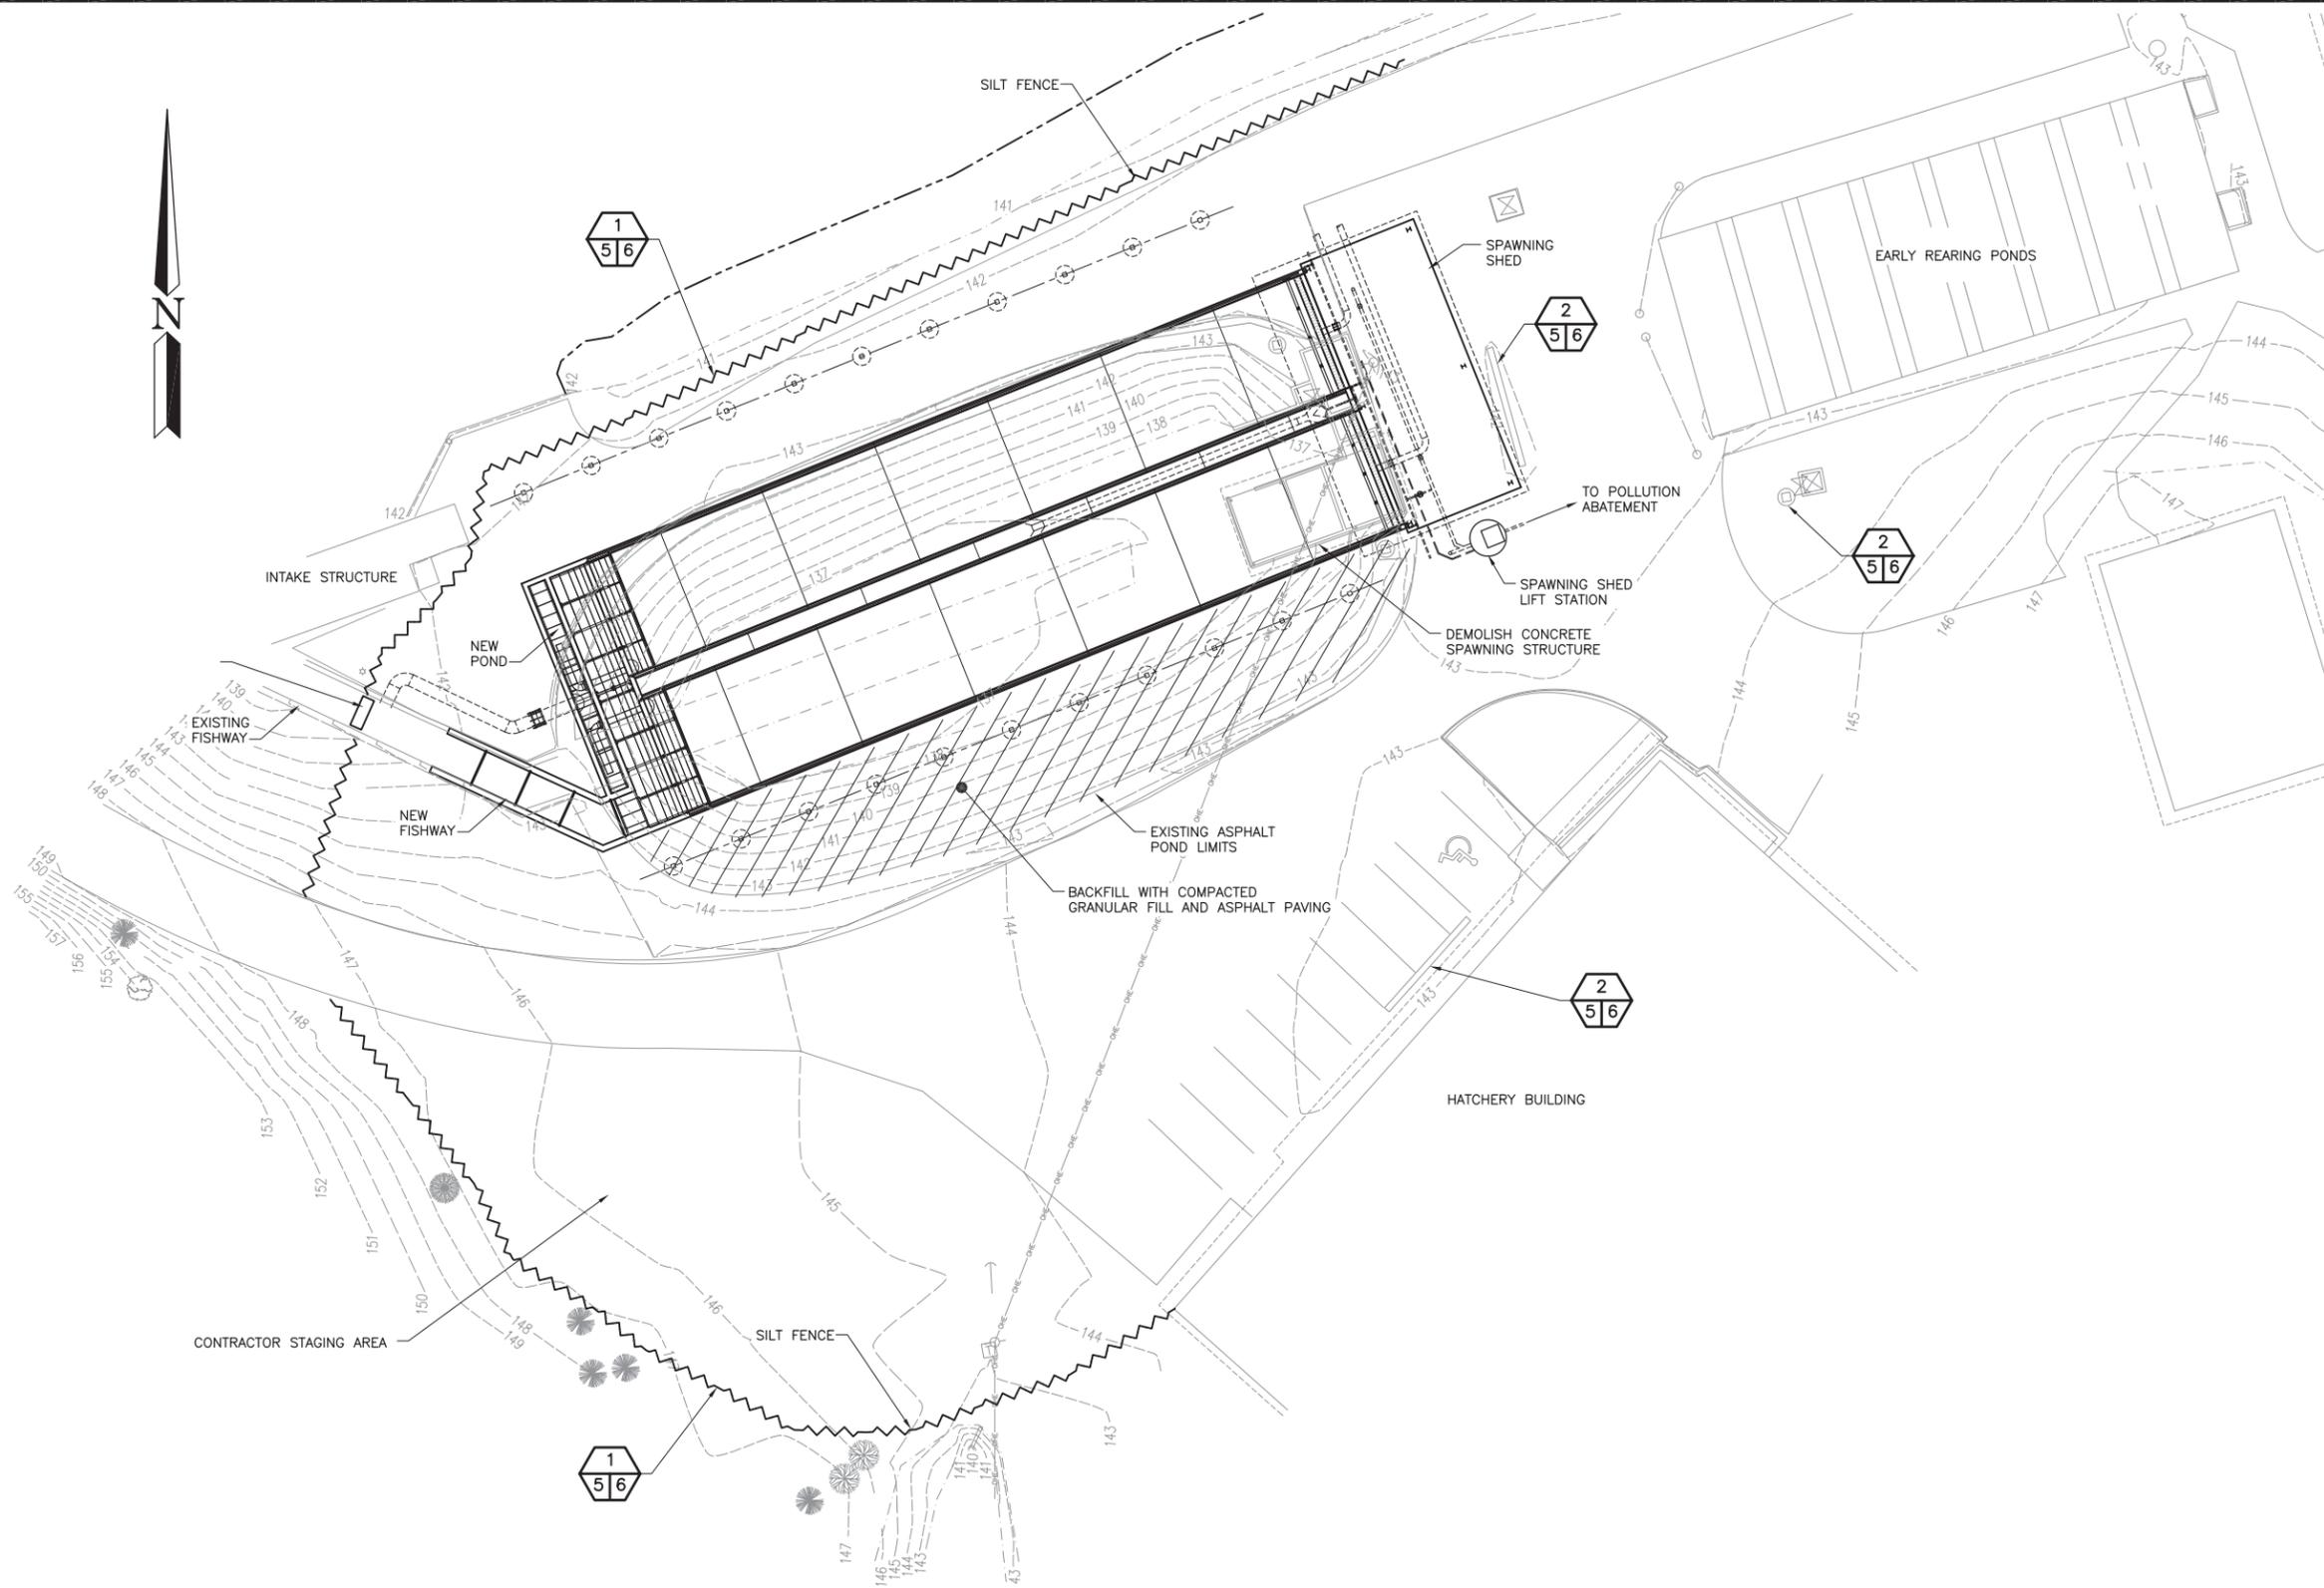

SITE PLAN
SCALE: 1" = 30'

PERMIT DRAWINGS



WASHINGTON STATE
DEPARTMENT OF FISH AND WILDLIFE

SYM	DATE	REVISION DESCRIPTION	BY
APPROVED AND RELEASED FOR CONSTRUCTION			
CHIEF ENGINEER		DATE:	DESIGNED BY
PROGRAM		DATE:	CHECKED BY
			DRAWN BY
			DATE: October 31, 2012


0 ——— 1"
BAR MEASURES
ONE INCH ON
ORIGINAL DRAWINGS

FORKS CREEK HATCHERY
ADULT HOLDING FACILITY
EROSION CONTROL PLAN

PROJECT NO.
SHEET **5** OF **6**


WHEN SPECIFIED IN THE CONTRACT, INSTALL BACKUP SUPPORT FOR THE GEOTEXTILE, SEE STD SPEC 8.01.3(9)A

GEOTEXTILE FOR TEMPORARY SILT FENCE, SEE PROJECT SPECIFICATIONS


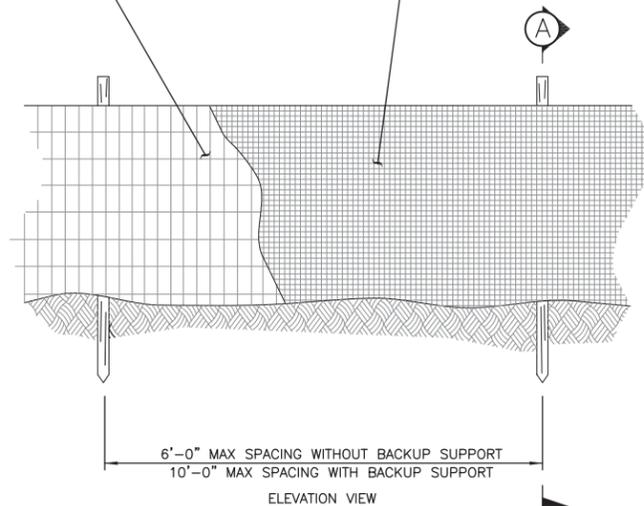


NOTES:

1. MAXIMIZE DETENTION OF STORMWATER BY PLACING FENCE AS FAR AWAY FROM TOE OF SLOPE AS POSSIBLE WITHOUT ENCRANCHING ON SENSITIVE AREAS OR OUTSIDE OF THE CLEARING BOUNDARIES.
2. INSTALL SILT FENCING ALONG CONTOURS WHENEVER POSSIBLE.
3. INSTALL THE ENDS OF THE SILT FENCE TO POINT SLIGHTLY UP SLOPE TO PREVENT SEDIMENT FROM FLOWING AROUND THE ENDS OF THE FENCE.
4. PERFORM MAINTENANCE IN ACCORDANCE WITH PROJECT SPECIFICATIONS.

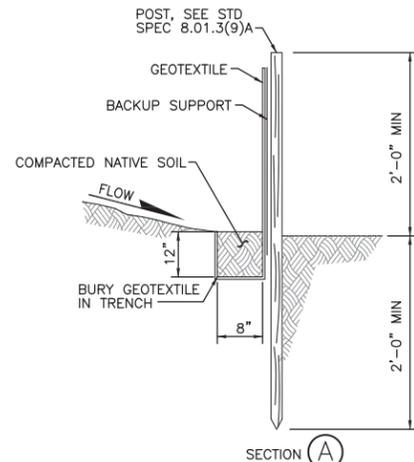

SILT FENCE
NOT TO SCALE

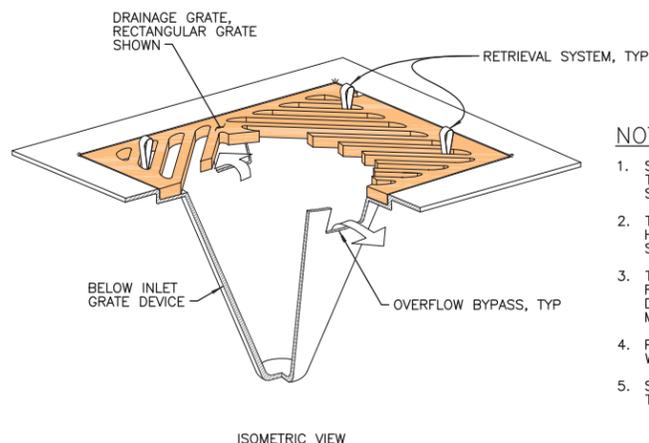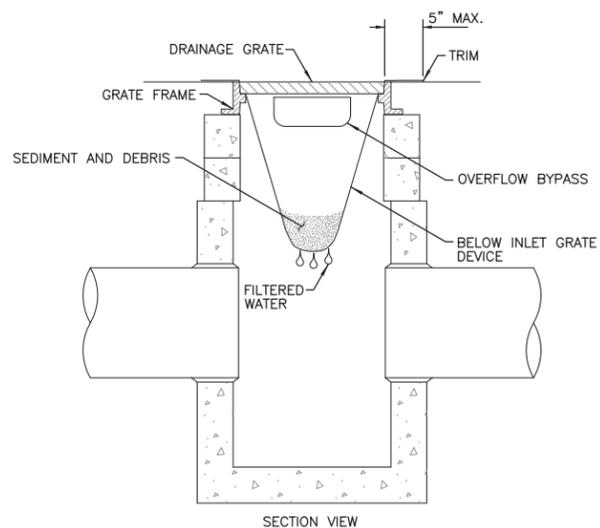

NOTES:

1. SIZE THE BELOW INLET GRATE DEVICE FOR THE STORM WATER STRUCTURE IT WILL SERVICE.
2. THE BELOW INLET GRATE DEVICE SHALL HAVE A BUILT IN HIGH FLOW RELIEF SYSTEM (OVERFLOW BYPASS).
3. THE RETRIEVAL SYSTEM MUST ALLOW REMOVAL OF THE BELOW INLET GRATE DEVICE WITHOUT SPILLING THE COLLECTED MATERIAL.
4. PERFORM MAINTENANCE IN ACCORDANCE WITH PROJECT SPECIFICATIONS.
5. SIMILAR PROTECTION STEPS 1-4 APPLY TO TRENCH DRAINS.

INLET PROTECTION
NOT TO SCALE



PERMIT DRAWINGS



WASHINGTON STATE
DEPARTMENT OF FISH AND WILDLIFE

SYM	DATE	REVISION DESCRIPTION	BY
APPROVED AND RELEASED FOR CONSTRUCTION			
CHIEF ENGINEER		DATE:	
PROGRAM		DATE:	

0 1"
BAR MEASURES
ONE INCH ON
ORIGINAL DRAWINGS

DESIGNED BY _____
CHECKED BY _____
DRAWN BY _____
DATE: October 31, 2012

FORKS CREEK HATCHERY
ADULT HOLDING FACILITY
EROSION CONTROL DETAILS

PROJECT NO.

SHEET 6 OF 6