

SEPA CHECKLIST FIGURES



Figure 1. Trout Lodge Hatchery, location of WDFW short-term, engineering activities.



Figure 2. Trout Lodge Hatchery, WDFW owned lands, Grant County, WA.

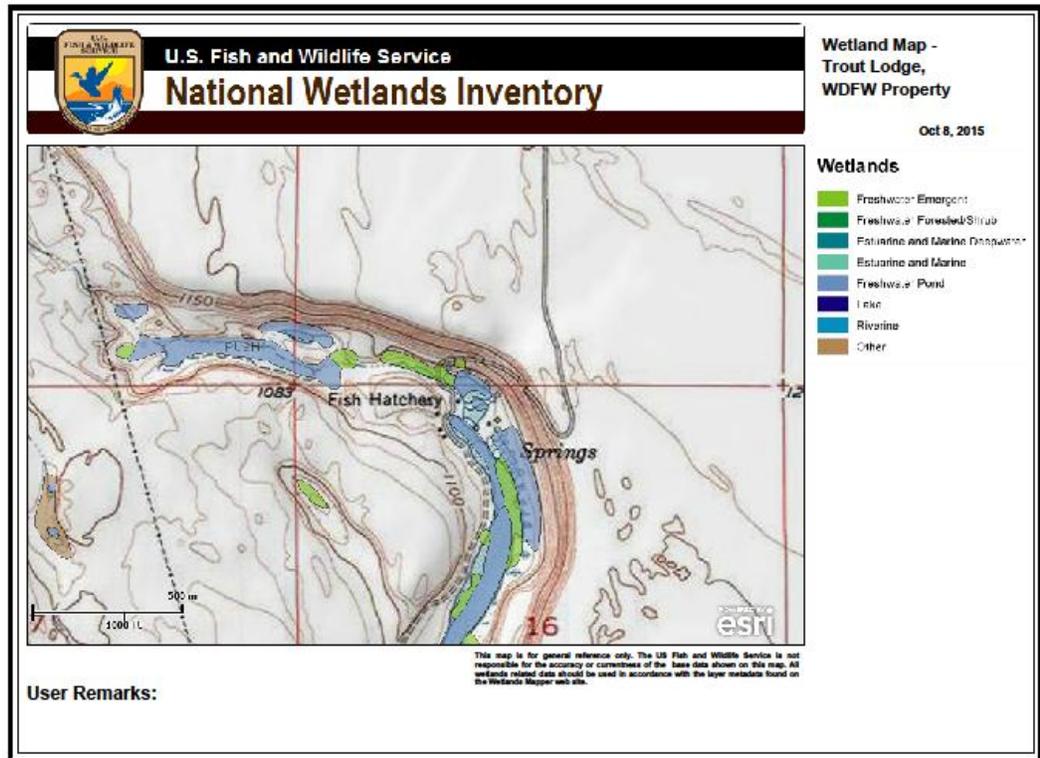


Figure 3. Wetland Inventory for WDFW Lands, Trout Lodge Hatchery.


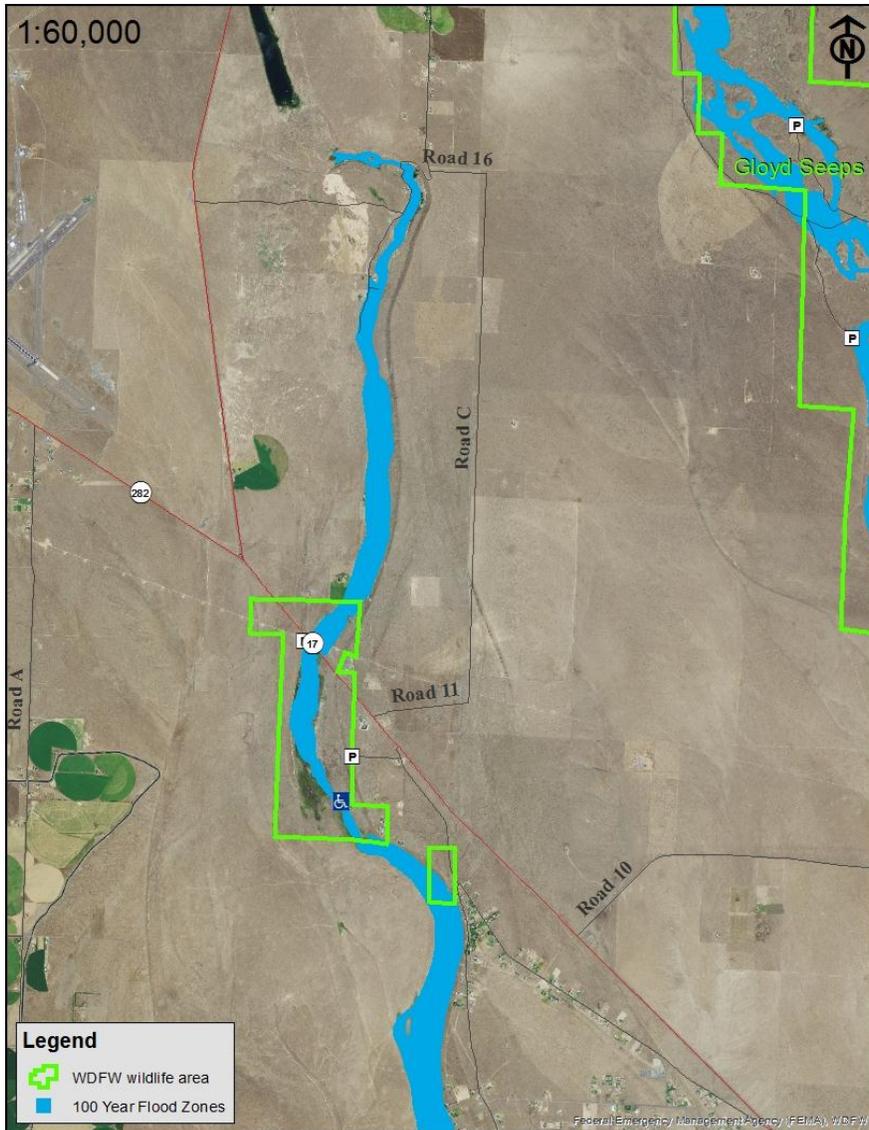


Figure 4. 100 year flood zone, WDFW owned lands, Trout Lodge Facility.



**Columbia Basin
Wildlife Area
Gloyd Seeps**

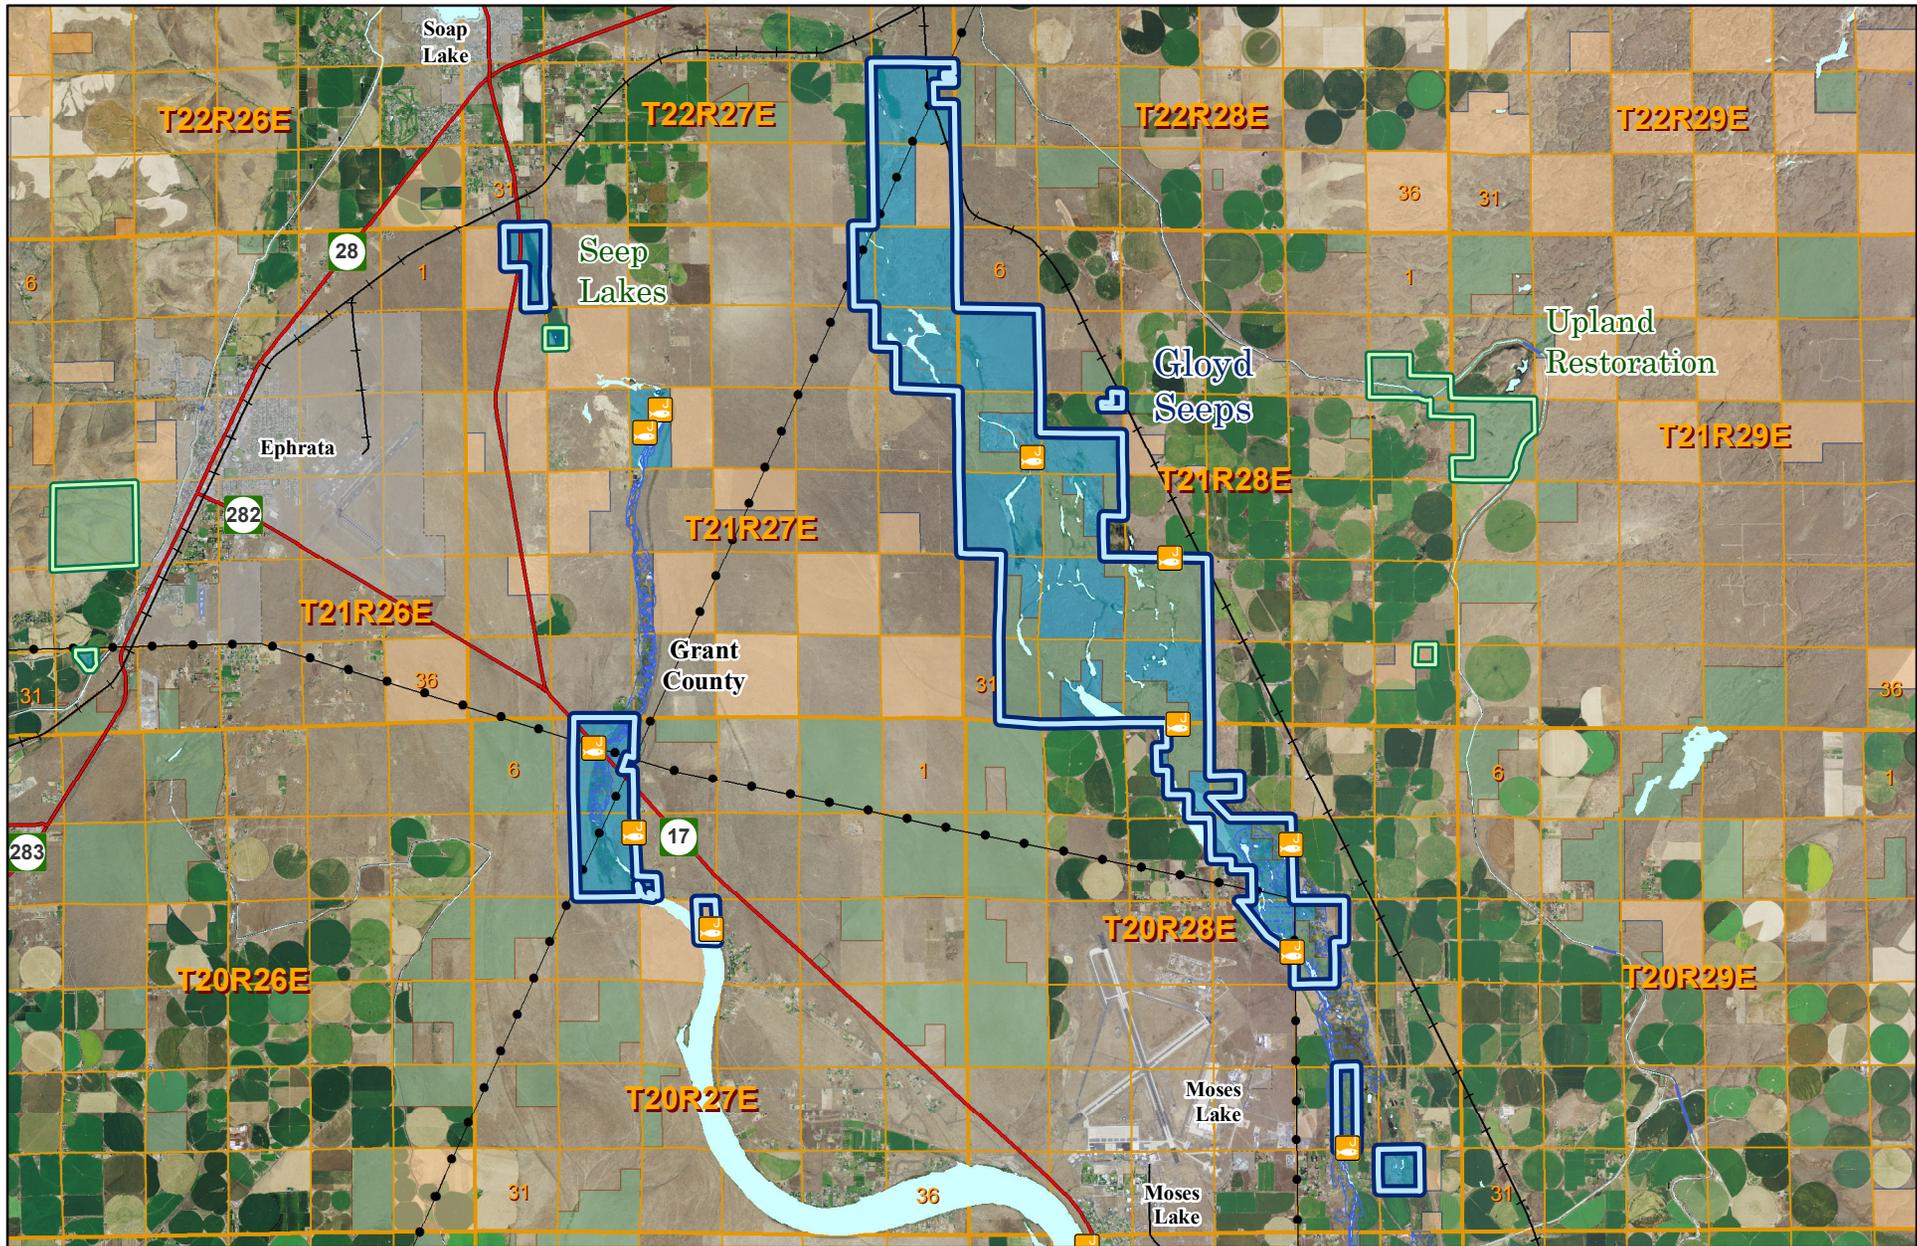

**WA Dept of Fish and Wildlife
(WDFW) Administered Land**

-  Featured Wildlife Area
-  WDFW Wildlife Area
-  Department Owned Land
-  WDFW Access Site



Disclaimer

Due to the dynamic nature of the data and the need to rely on outside sources of information the Washington Department of Fish and Wildlife (WDFW) cannot accept responsibility for errors or omissions in the data and information contained in this product. There are no warranties that accompany the maps and information contained in this product. For more accurate information concerning this Wildlife Area Unit contact the WDFW Regional office that manages this unit.

Map Produced: June, 2015


FOR OFFICIAL USE ONLY
PROJECT NAME (AND STATE)
SUB DIVISION (DIVISION AND UNIT) OF STATE
PRINCIPAL / FEATURE
SUB FEATURE
CONTENTS
Not For Distribution

STATION NAME (CITY, ST) YYYY-MM-DD
DETAILS (UP TO THREE LINES)
PRJ-STA-SEQ
SHEET 1 OF 1





NOTES

1. HORIZONTAL CONTROL: THE 2011 WORK BASED ON CONTROL POINT EPHR (WSRN) and MSLK (WSRN).
2. VERTICAL CONTROL: BASED ON ELEVATIONS AT CONTROL POINT EPHR (WSRN) and MSLK (WSRN).
3. Horizontal and Vertical Datum: Washington State Plane, South Zone North American Datum 1983, Vertical Datum NAVD '88, U.S. Survey Feet.
4. SURVEY INFORMATION: SITE WAS SURVEYED ON DECEMBER 12, 2011 USING TRIMBLE R8 GPS RECEIVERS.

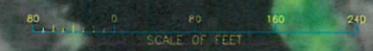

DATE AND TIME PLOTTED:
DATE AND TIME PLOTTED BY:
NOT PLOTTED

CAD SYSTEM
AUTOCAD
CAD FILENAME
UNKNOWN

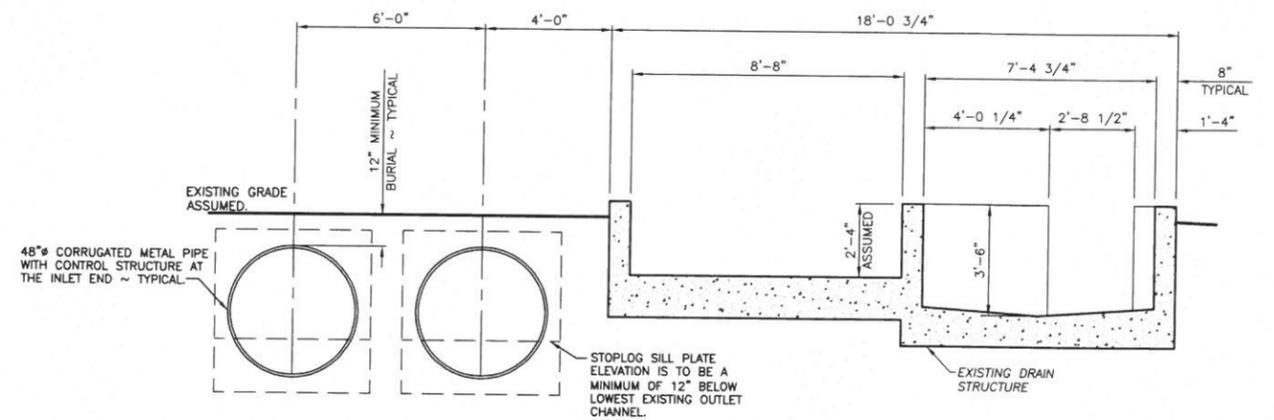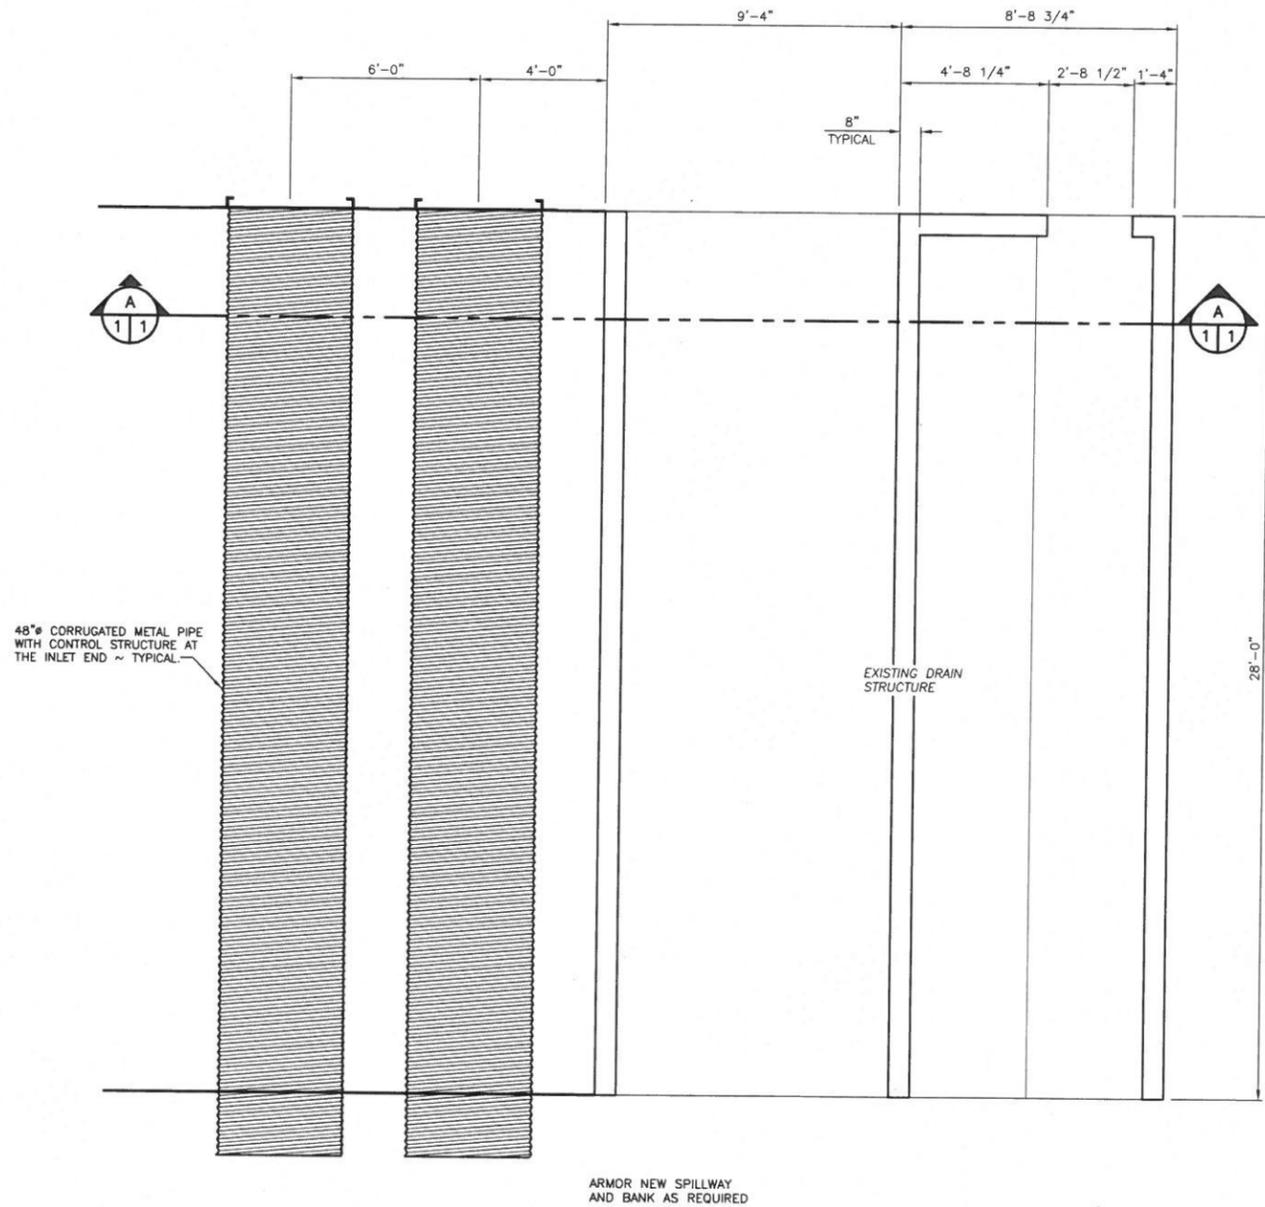

SECTION A
SCALE: 3/8" = 1'-0"

SEEP POND OUTLET STRUCTURE PLAN
SCALE: 3/8" = 1'-0"

WASHINGTON STATE
DEPARTMENT OF FISH AND WILDLIFE


SYMBOL		DATE	REVISION DESCRIPTION	BY
APPROVED AND RELEASED FOR CONSTRUCTION				
CHIEF ENGINEER		DATE:		
PROGRAM		DATE:		

0 1" BAR MEASURES ONE INCH ON ORIGINAL DRAWINGS
DESIGNED BY K. KUYKENDALL
CHECKED BY
DRAWN BY D. SMITH
DATE 8/5/2015


TROUT LODGE HATCHERY
EMERGENCY WATER CONTROL
SEEP POND OUTLET STRUCTURE
PLAN AND SECTION

PROJECT NO.
SHEET 1 OF 3

NOT FOR CONSTRUCTION

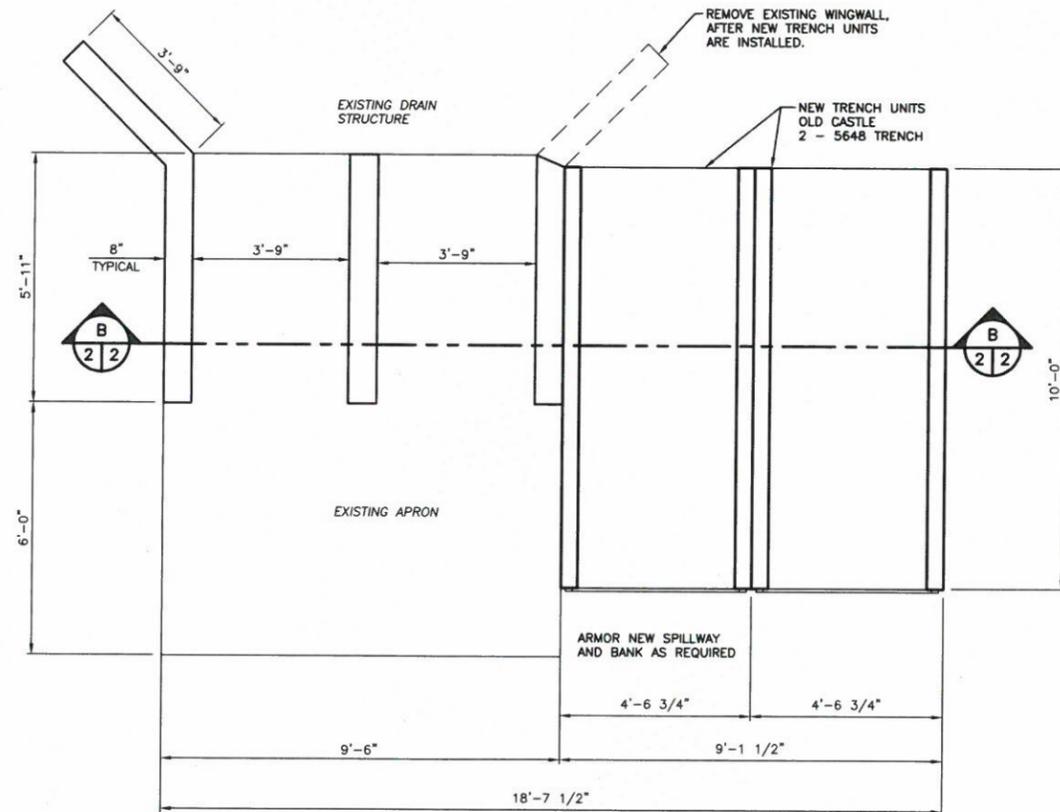

**WATER CONTROL STRUCTURE
AT TROUTLODGE 2 LOCATION**
SCALE: 1" = 1'-0"

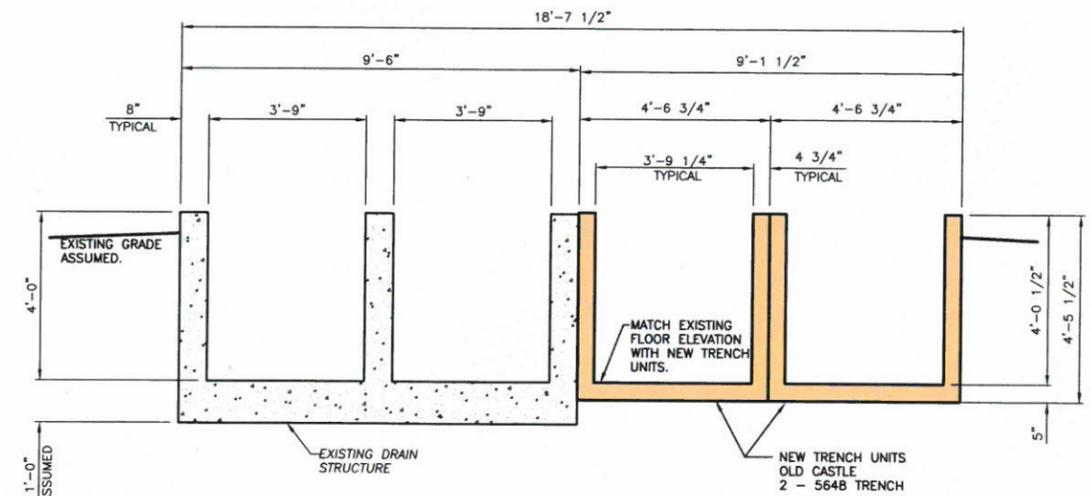

SECTION B-B
SCALE: 1/2" = 1'-0"

**WASHINGTON STATE
DEPARTMENT OF FISH AND WILDLIFE**


SYMBOL		DATE		BY		DESIGNED BY	
						K. KUYKEDALL	
CHIEF ENGINEER				DATE		DRAWN BY	
						D. SMITH	
PROGRAM				DATE		8/5/2015	

**NOT FOR
CONSTRUCTION**

0 1"
BAR MEASURES
ONE INCH ON
ORIGINAL DRAWINGS

**TROUT LODGE HATCHERY
EMERGENCY WATER CONTROL
WATER CONTROL STRUCTURE
PLAN AND SECTION**

PROJECT NO.
SHEET 2 OF 3

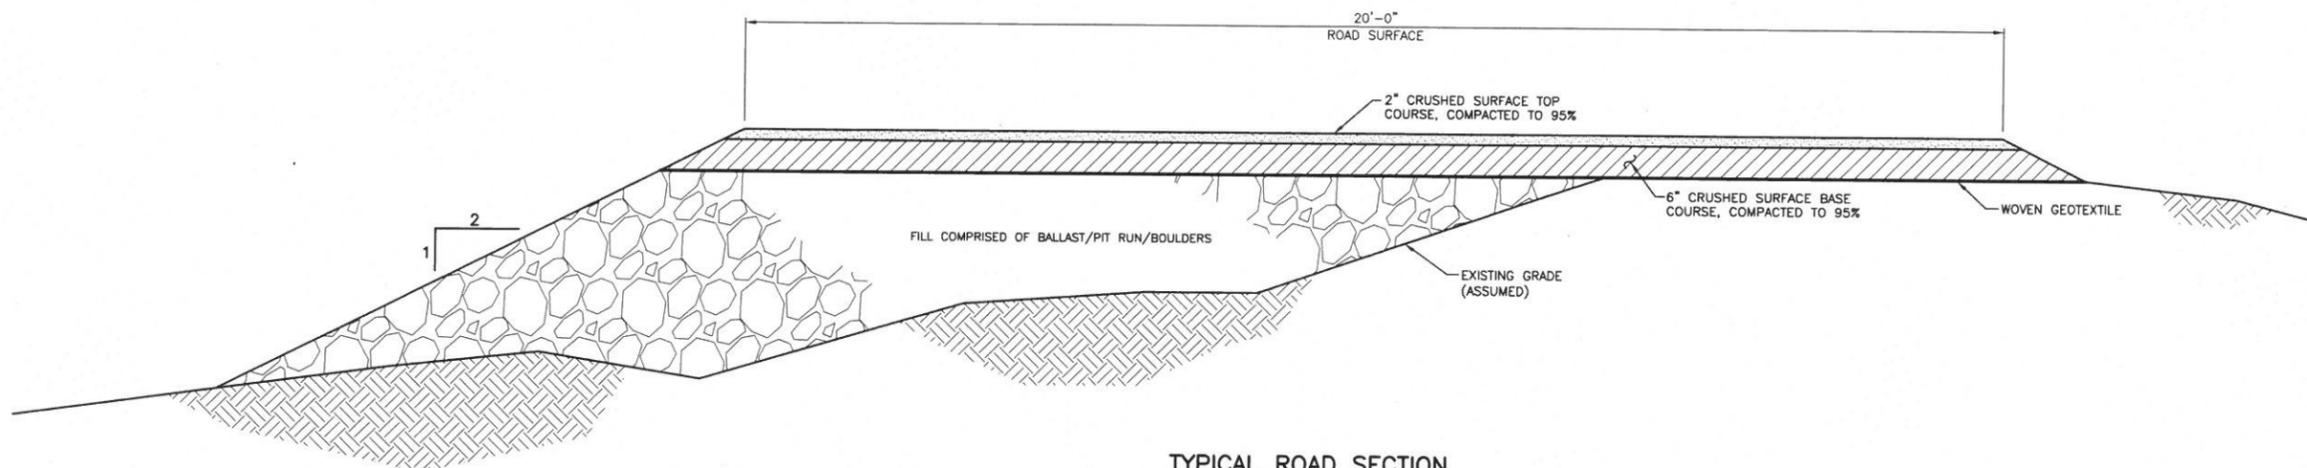

TYPICAL ROAD SECTION

NOT TO SCALE
 APPROXIMATE LENGTH OF NEW ROAD IS 200'±.
 EXISTING GRADE VARIES. SHOWN IS AT EXISTING
 POND TO BE FILL FOR THE NEW ROAD ACCESS.

WASHINGTON STATE
 DEPARTMENT OF FISH AND WILDLIFE

SYMBOL	DATE	REVISION DESCRIPTION	BY
APPROVED AND RELEASED FOR CONSTRUCTION			
CHIEF ENGINEER		DATE	
PROGRAM		DATE	

0 ——— 1"
 BAR MEASURES
 ONE INCH ON
 ORIGINAL DRAWINGS

DESIGNED BY: K. KUYKEDALL
 CHECKED BY:
 DRAWN BY: D. SMITH
 DATE: 8/5/2015

TROUT LODGE HATCHERY
 EMERGENCY WATER CONTROL
 TYPICAL ROAD SECTION

PROJECT NO.
 SHEET 3 OF 3

NOT FOR
 CONSTRUCTION

TROUT LODGE I PHASE II



SECTION 16, TWP. 21 N, RGE 27 E. WM

- LEGEND**
- 6" P.V.C. "TEE"
 - GRATE
 - LIGHT STANDARD
 - 6" P.V.C. DOWN-TURNED ELBOW
 - 8" P.V.C. DOWN-TURNED ELBOW
 - 4" VERTICLE P.V.C. PIPE
 - 8" P.V.C. VERTICLE PIPE
 - WATER SPIGOT
 - POWER STAND
 - MANHOLE COVER
 - CLEANOUT
 - POWER BOARD
 - 48" +/- PIPE
 - 36" PIPE
 - 24" PIPE
 - 4" PIPE
 - POWER POLE
 - OVERHEAD WIRE (PER CLIENT)
 - UNDERGROUND POWER (PER CLIENT)
 - UNDERGROUND TELEPHONE (PER CLIENT)
 - UNDERGROUND DOMESTIC WATER (PER CLIENT)
 - UNDERGROUND CULVERT AS NOTED (PER CLIENT)
 - UNDERGROUND DRAIN LINE (PER CLIENT)
 - EDGE OF CREEK
 - EDGE OF POND
 - FENCE
 - EDGE OF GRAVEL
 - EDGE OF CONCRETE
 - CONCRETE

NOTE: GENETICS I, II & HATCHERY (DEEP TANK BUILDING) ALL HAVE THEIR OWN SELF CONTAINED DOMESTIC WATER SYSTEMS, AND ARE PUMPED FROM INSIDE WELLS.

SURVEYOR'S NOTES

1. THIS SURVEY DOES NOT PURPORT TO SHOW EASEMENTS OF RECORD OR THE LOCATION OF UTILITIES - EXCEPT AS SHOWN.
2. THE INSTRUMENTS UTILIZED WERE: TRIMBLE 5600, D.R. 200+ TOTAL STATION. (ROBOTIC)
3. BASIS OF BEARING: ASSUMED.
4. THIS SURVEY MEETS OR EXCEEDS THE MINIMUM STANDARDS SET FORTH IN WAC332-130.
5. VERTICAL DATUM = ASSUMED.
6. ONLY ABOVE GROUND VISIBLE EXISTING UTILITIES WERE LOCATED THIS SURVEY.
7. ALL UTILITIES SHOULD BE VERIFIED PRIOR TO ANY DESIGN OR CONSTRUCTION.
8. THIS DRAWING NOT INTENDED FOR THE USE OF ANY DESIGN OR CONSTRUCTION.
9. ALL UNDERGROUND UTILITIES SHOW HEREON WERE PROVIDED BY CLIENT AND ARE APPROXIMATE ONLY.
10. NO BOUNDARY WORK WAS DONE THIS SURVEY. ADDITIONAL RESEARCH NEEDS TO BE DONE TO DETERMINE THE EXACT LOCATION OF THE BOUNDARY.

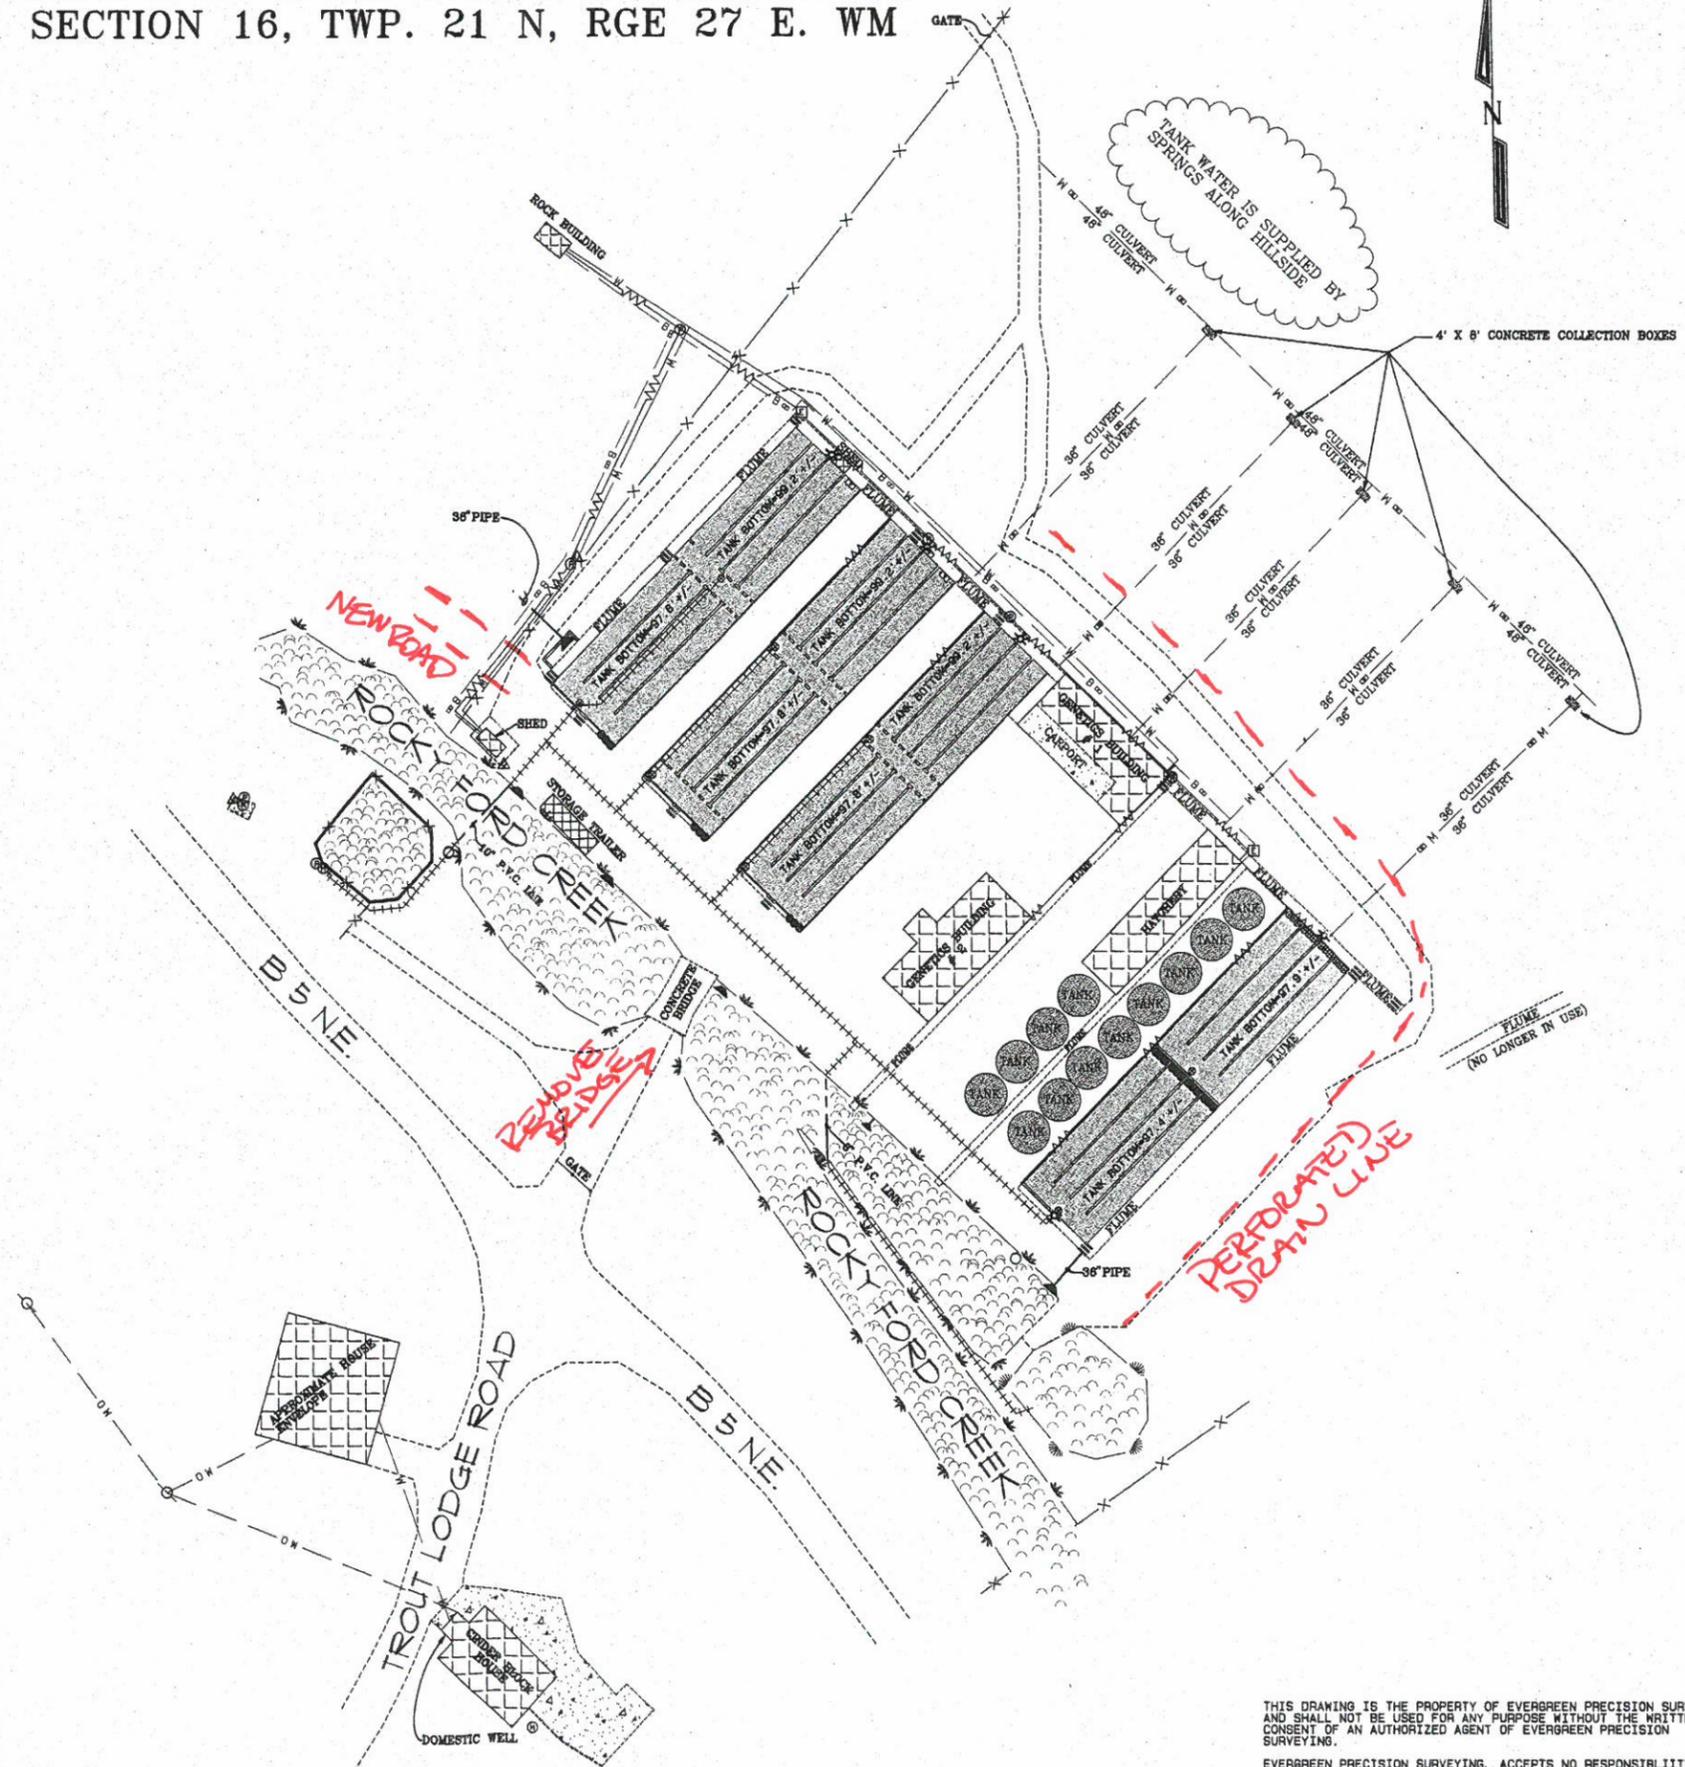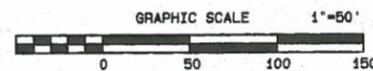

DATE: JUNE 21, 2006
SCALE: 1" = 50'
PROJECT NUMBER: 00732

DATE	REVISION
12/30	ADDED UNDERGROUND UTILITIES (PROVIDED BY CLIENT)

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 Brentley@epsurveying.com

ASBUILT SITE PLAN

TROUT LODGE
 BILL TOWNSEND
 PO BOX 1290
 SUMNER, WA 98390
 253-863-0446

SHEET 1 OF 1

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