



# WASHINGTON DEPARTMENT OF FISH AND WILDLIFE

## SOOS CREEK HATCHERY WATER SUPPLY TREATMENT SCHEMATIC DESIGN DRAWINGS




### OWNER:

WASHINGTON DEPARTMENT OF FISH AND WILDLIFE  
600 CAPITOL WAY NORTH  
OLYMPIA, WA 98501  
(360-902-8300)

### PROJECT ADDRESS

SOOS CREEK FISH HATCHERY  
13030 SE AUBURN-BLACK DIAMOND ROAD  
AUBURN, WA 98092  
KING COUNTY

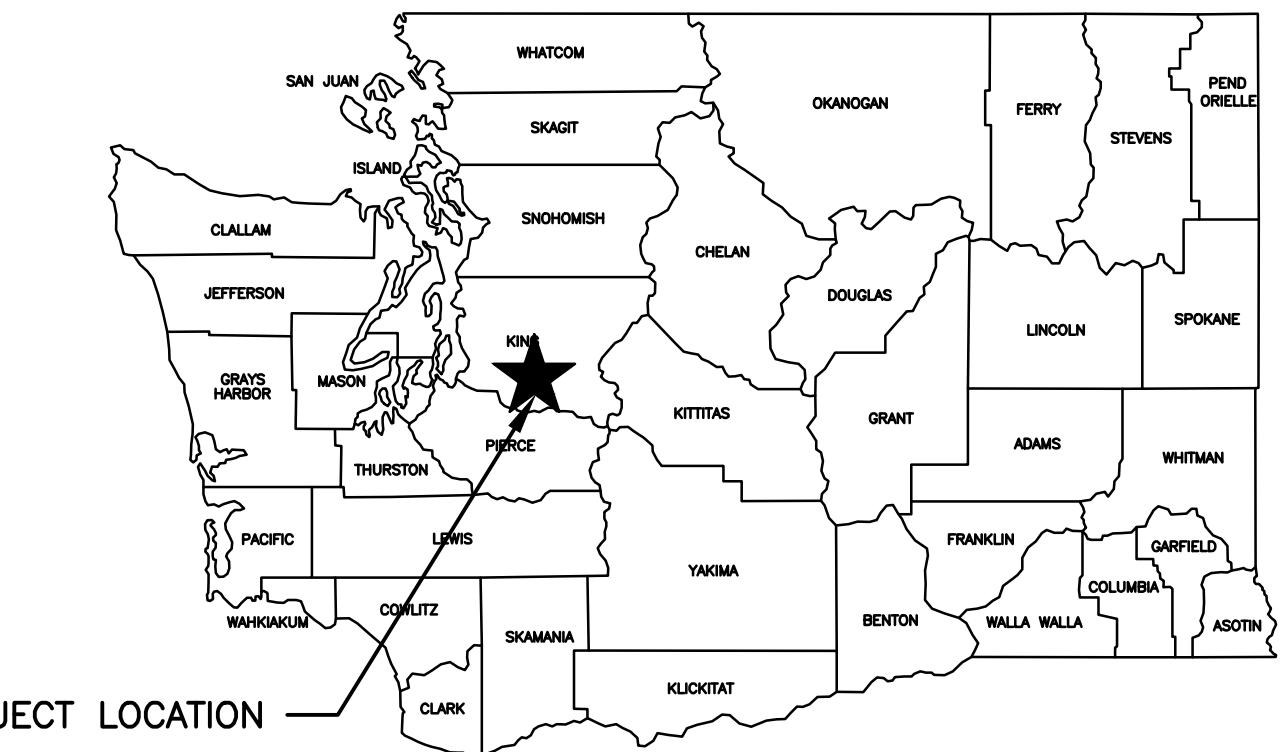

PROJECT LOCATION

STATE MAP  
NOT TO SCALE

### LEGAL DESCRIPTIONS:

PARCEL 162105-9005  
SE 1/4 OF NE 1/4 LESS NP R/W LESS CO RD & LESS ST HWY  
PARCEL 162105-9015  
POR OF NE 1/4 OF SE 1/4 LY NWLY OF H H HOWARD RD  
PARCEL 162105-9033  
BEG SE COR OF NE 1/4 OF NE 1/4 TH N 89-15-09 W 601.20 FT TO  
ELY R/W NP RW TH NELY ALG SD R/W 290.70 FT TH S 60-20-00 E  
526.24 FT TO POB LESS CO RD

### SITE ZONING:

COUNTY ZONING CLASSIFICATION  
A-10 AGRICULTURAL, ONE DU PER 10 ACRES  
SHORELINE ENVIRONMENTAL DESIGNATION  
RESOURCE SHORELINE (ABOVE OHW)/ AQUATIC SHORELINE (BELOW OHW)

### PROJECT SUMMARY:

THE PROPOSED IMPROVEMENTS ARE FOR ADDRESSING FISH DISEASE ISSUES  
AT THE HATCHERY, IMPROVING WATER REUSE CAPABILITIES, IMPROVING  
SEDIMENT MANAGEMENT PROCESSES, AND ADDRESSING WATER SUPPLY  
HYDRAULIC LIMITATIONS IN VARIOUS LOCATIONS

### SURVEY REFERENCES:

STATE OF WASHINGTON UNRECORDED SURVEY OF GREEN  
RIVER HATCHERY DATED JUNE, 19 1970.

N.P.R. PALMER CUT-OFF RIGHT OF WAY PLAT N2-R21  
RECORDED JULY 10, 1970.

KING COUNTY WASHINGTON SHORT PLAT NO. 179036.

KING COUNTY SURVEY NO. 558 H.H. HOWARD ROAD.

HORIZONTAL DATUM:


NAD 83(2011) EPOCH 2010.00 WASHINGTON STATE  
PLANE COORDINATE SYSTEM, NORTH ZONE, US

SURVEY FEET.

COMBINED SCALE FACTOR: 1.00004086

CONVERGENCE ANGLE: -00°59'32.02"

VERTICAL DATUM:  
NAVD 88 (GEOD 2012) (CONTROL SET DURING  
SURVEY PERFORMED ON SOOS CREEK HATCHERY IN  
2012.)

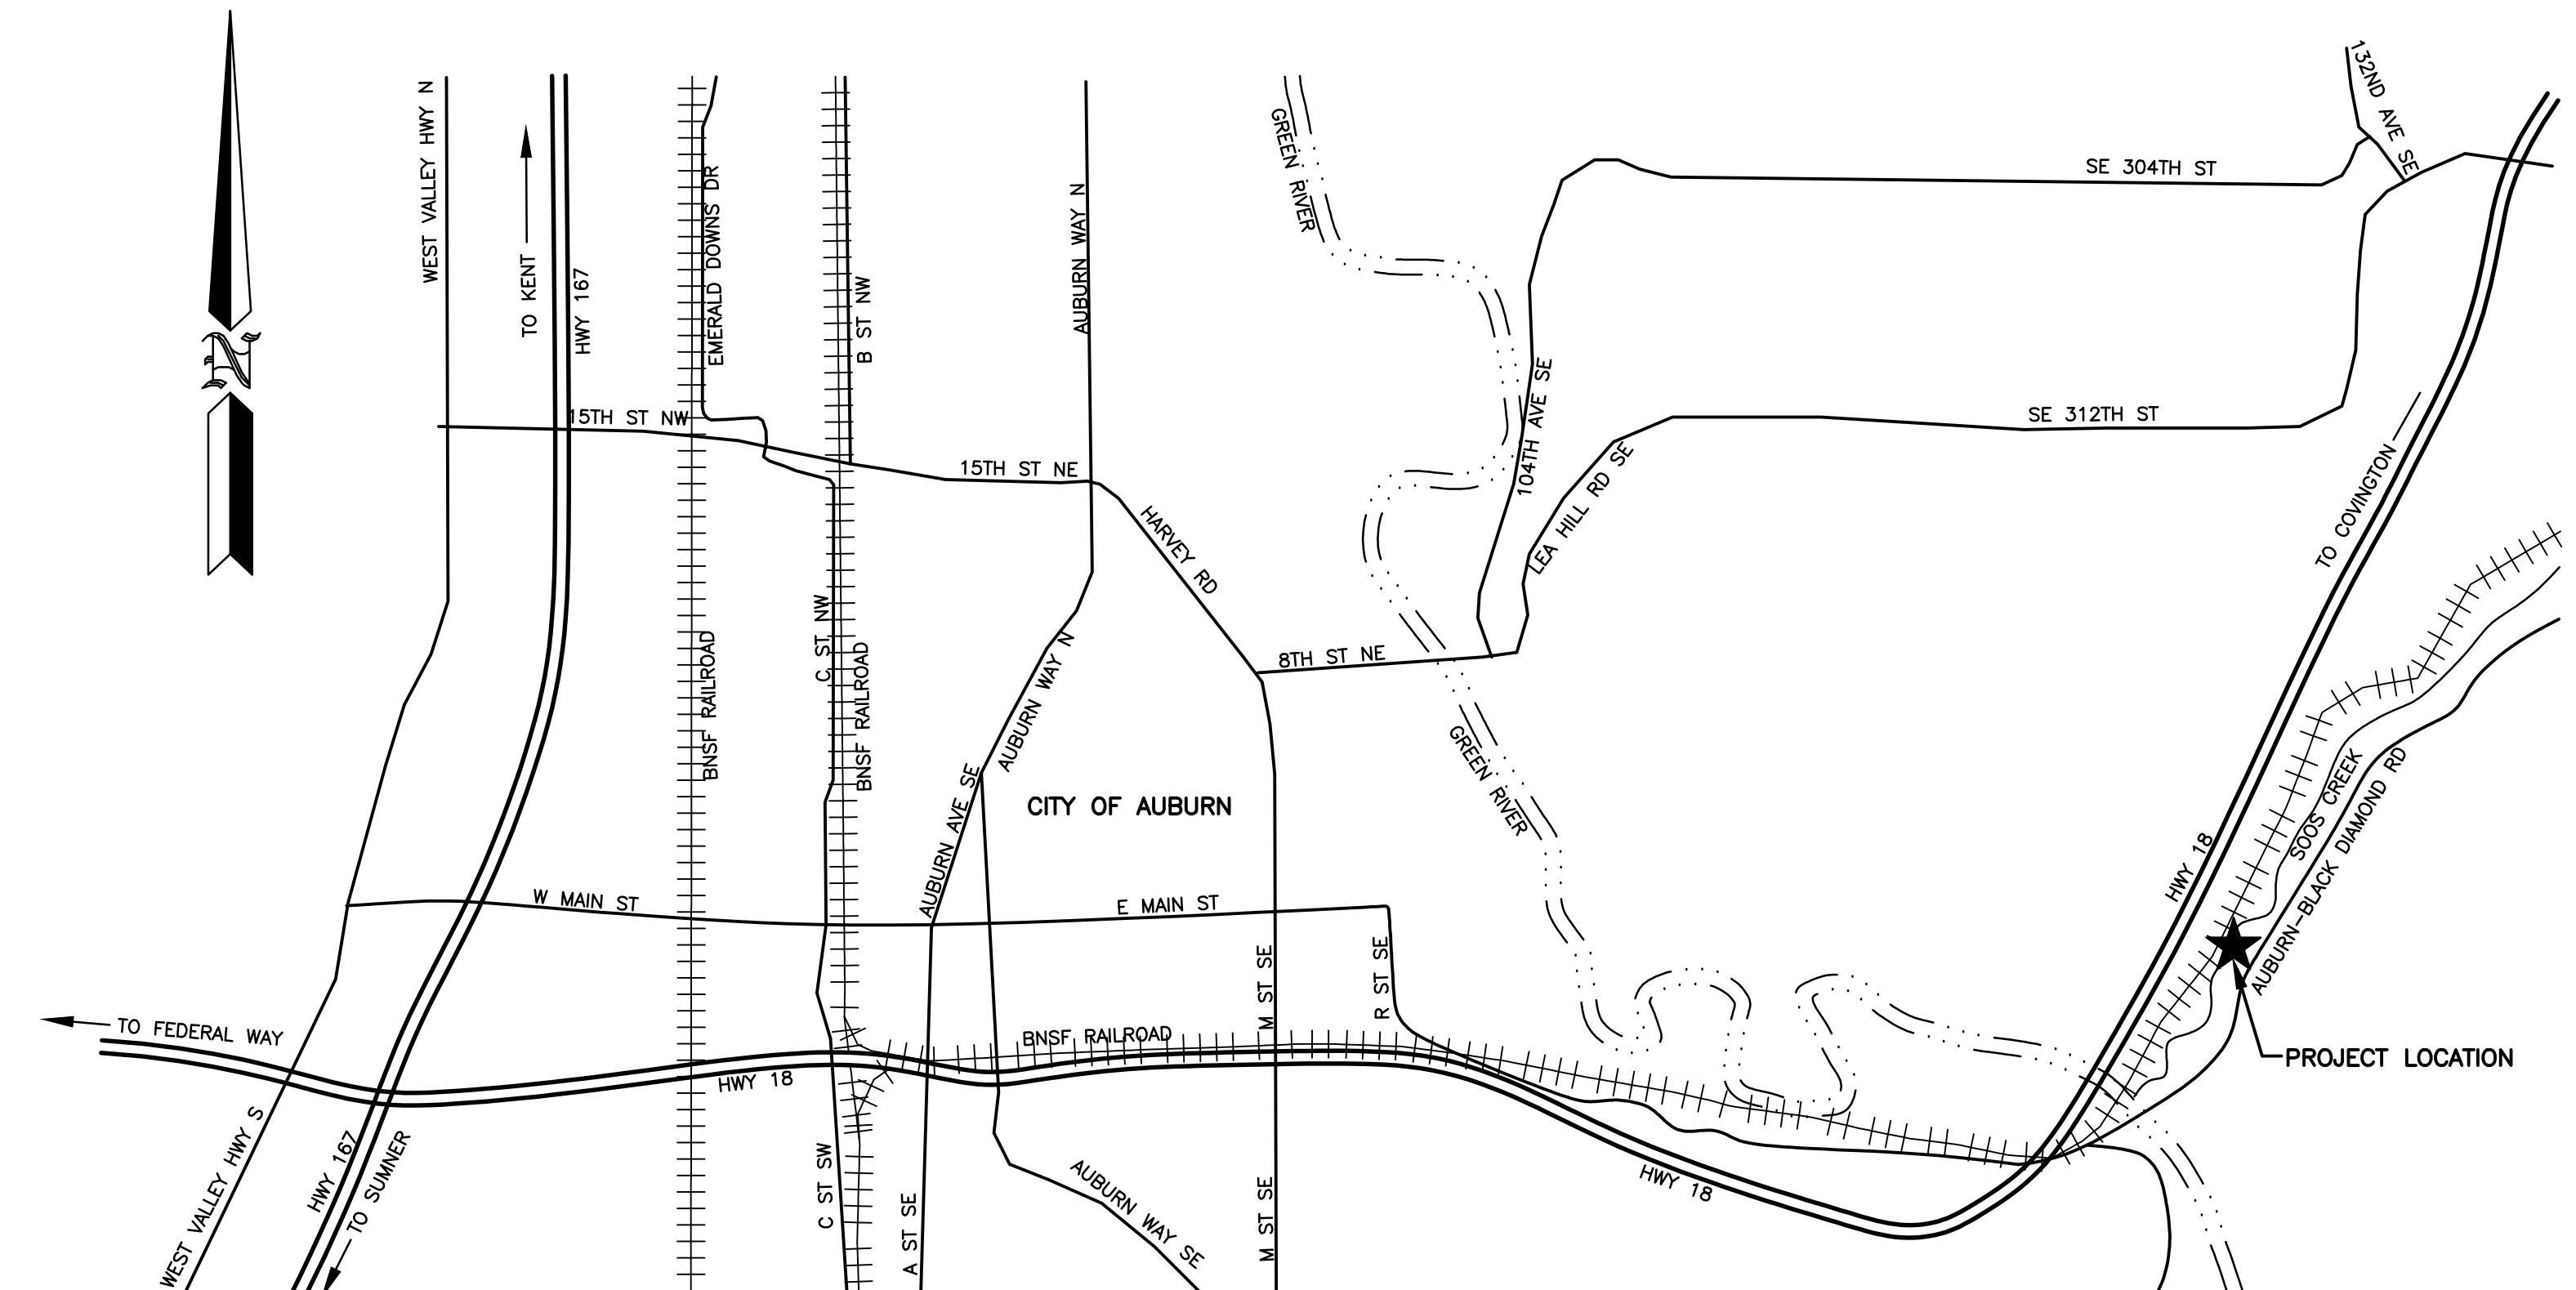


VICINITY MAP  
NOT TO SCALE

### PROJECT ADDRESS

SOOS CREEK FISH HATCHERY  
13030 SE AUBURN-BLACK DIAMOND ROAD  
AUBURN, WA 98092

PROJECT NO.  
PROJECT

SHEET 1 OF 74

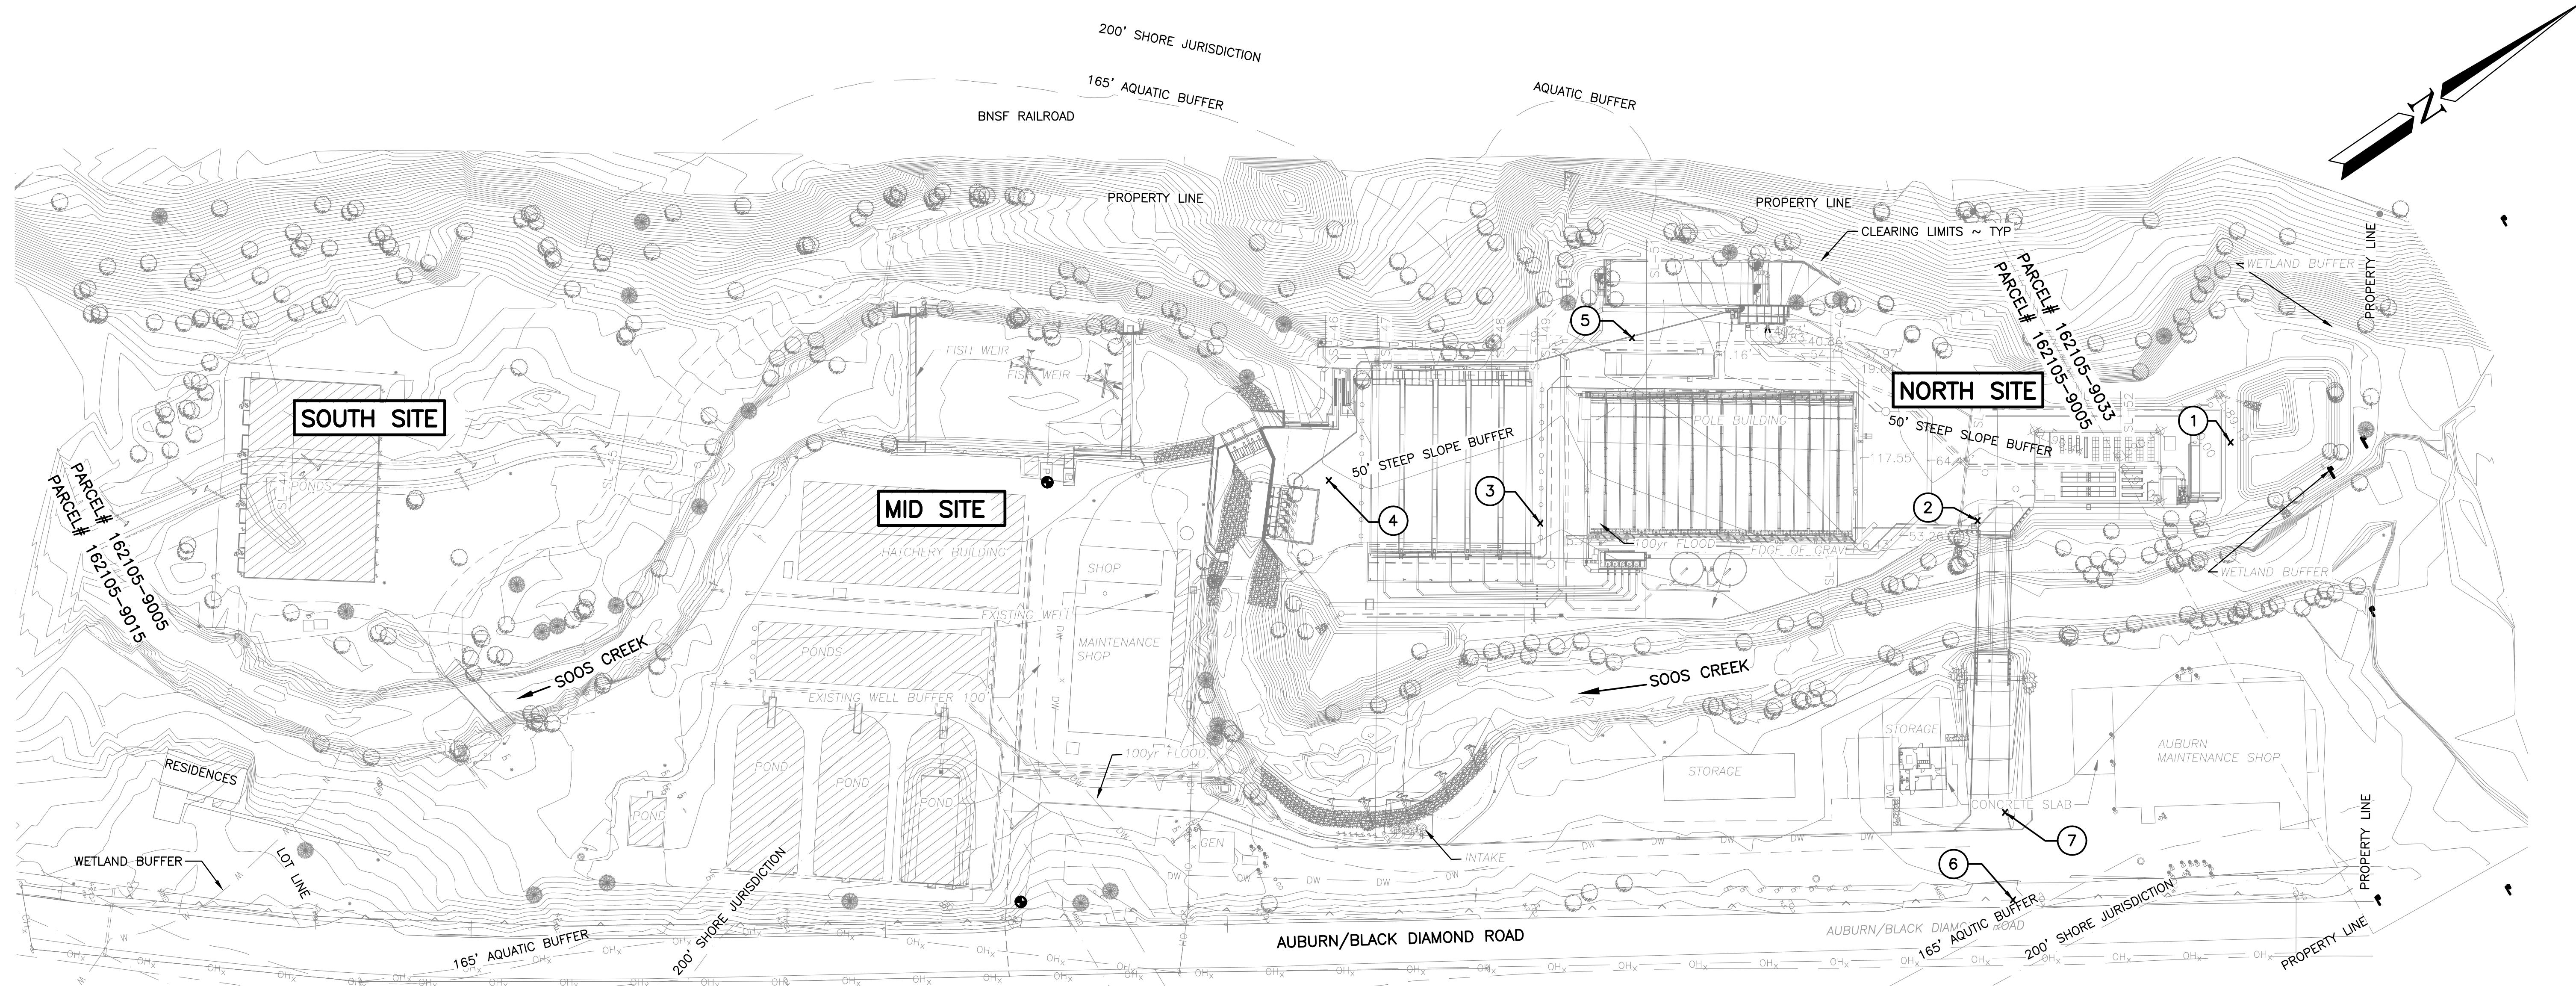

## SURVEY REFERENCES:

STATE OF WASHINGTON  
UNRECORDED SURVEY OF  
GREEN RIVER HATCHERY DATED  
JUNE, 19 1970.  
N.P.R. PALMER CUT-OFF  
RIGHT OF WAY PLAT N2-R21  
RECORDED JULY 10, 1970.  
KING COUNTY WASHINGTON  
SHORT PLAT NO. 179036.  
KING COUNTY SURVEY NO.  
558 H.H. HOWARD ROAD.

PARCEL 162105-9005  
SE 1/4 OF NE 1/4 LESS NP  
R/W LESS CO RD & LESS ST  
HWY

HWT  
PARCEL 162105-9015  
POR OF NE 1/4 OF SE 1/4  
LY NWLY OF H H HOWARD RD

PARCEL 162105-9033  
BEG SE COR OF NE 1/4 OF  
NE 1/4 T11 N R17 E

NE 1/4 TH N 89-15-09 W  
601.20 FT TO ELY R/W NP  
RW TH NELY ALG SD R/W  
290.70 FT TH S 60-20-00 E  
526.24 FT TO POB LESS CO  
RD

HORIZONTAL DATUM:  
NAD 83(2011) EPOCH  
2010.00 WASHINGTON STATE  
PLANE COORDINATE SYSTEM,  
NORTH ZONE, US SURVEY  
FEET.  
COMBINED SCALE FACTOR:  
1.00004086  
CONVERGENCE ANGLE:  
-00000000"

VERTICAL DATUM:  
NAVD 88 (GEOID 2012)  
(CONTROL SET DURING  
SURVEY PERFORMED ON  
SOOS CREEK HATCHERY IN  
2012.)

## **EXISTING SITE PLAN**

SCALE: 1" = 60'

| SURVEY CONTROL POINT DATA |           |            |             |
|---------------------------|-----------|------------|-------------|
| POINT #                   | NORTHING  | EASTING    | DESCRIPTION |
| 1                         | 116608.05 | 1309519.63 | CP          |
| 2                         | 116419.66 | 1309475.63 | HTK         |
| 3                         | 116142.82 | 1309315.93 | HTK         |
| 4                         | 116025.01 | 1309210.93 | HTK         |
| 5                         | 116269.09 | 1309232.77 | SPIKE       |
| 6                         | 116302.25 | 1309728.08 | PK NAIL     |
| 7                         | 116329.47 | 1309669.69 | PK NAIL     |

LEGEND

- |                    |                           |
|--------------------|---------------------------|
| —                  | ORDINARY HIGH WATER LINE  |
| —                  | NEW 100yr FLOOD LINE      |
| —                  | CONTOUR MAJOR             |
| —                  | CONTOUR MINOR             |
| EXISTING STRUCTURE | EXISTING LABEL TEXT       |
| —                  | EDGE OF GRAVEL            |
| — FF — FF —        | SILT FENCE                |
| — GB — GB —        | GRADE BREAK               |
| — — — — —          | RIGHT OF WAY              |
| —                  | EDGE OF ROAD PAVEMENT     |
| —                  | PROPERTY LINE BOUNDARY    |
| —                  | CLEARING LIMIT BOUNDARY   |
| — — — — —          | EXISTING 100yr FLOOD LINE |
| ⊕ EL:0.00          | SPOT ELEVATION            |
| ○                  | MANHOLE/OUTLET STRUCTURE  |
| ■                  | CATCH BASIN               |

# DISCIPLINE SHEET #

# G0.4

PROJECT NO.

PROJECT NO.  
XX:X##:###:#-#

|        |    |
|--------|----|
| STREET | OF |
| 1      | 74 |



*WASHINGTON DEPARTMENT OF  
FISH & WILDLIFE*

|  |      | <b>SCHEMATIC DESIGN</b><br><b>NOT FOR CONSTRUCTION</b><br><b>MAY 17, 2021</b> |    | 0 ————— 1"<br><b>BAR MEASURES</b><br><b>ONE INCH ON</b><br><b>22x34 DRAWINGS</b> |
|--|------|---|----|--|
| SYM                                    | DATE | REVISION DESCRIPTION  | BY | DESIGNED BY D. WHITBECK  |
| APPROVED AND RELEASED FOR CONSTRUCTION |      |   |    | CHECKED BY _____   |
| CHIEF ENGINEER ..... DATE: .....       |      |   |    | DRAWN BY STANTEC   |
| PROGRAM ..... DATE: .....              |      |   |    | DATE 05/17/2021  |


# **SOOS CREEK HATCHERY**

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## **WATER SUPPLY TREATMENT**

### **EXISTING SITE PLAN**

### **AND SURVEY CONTROL**

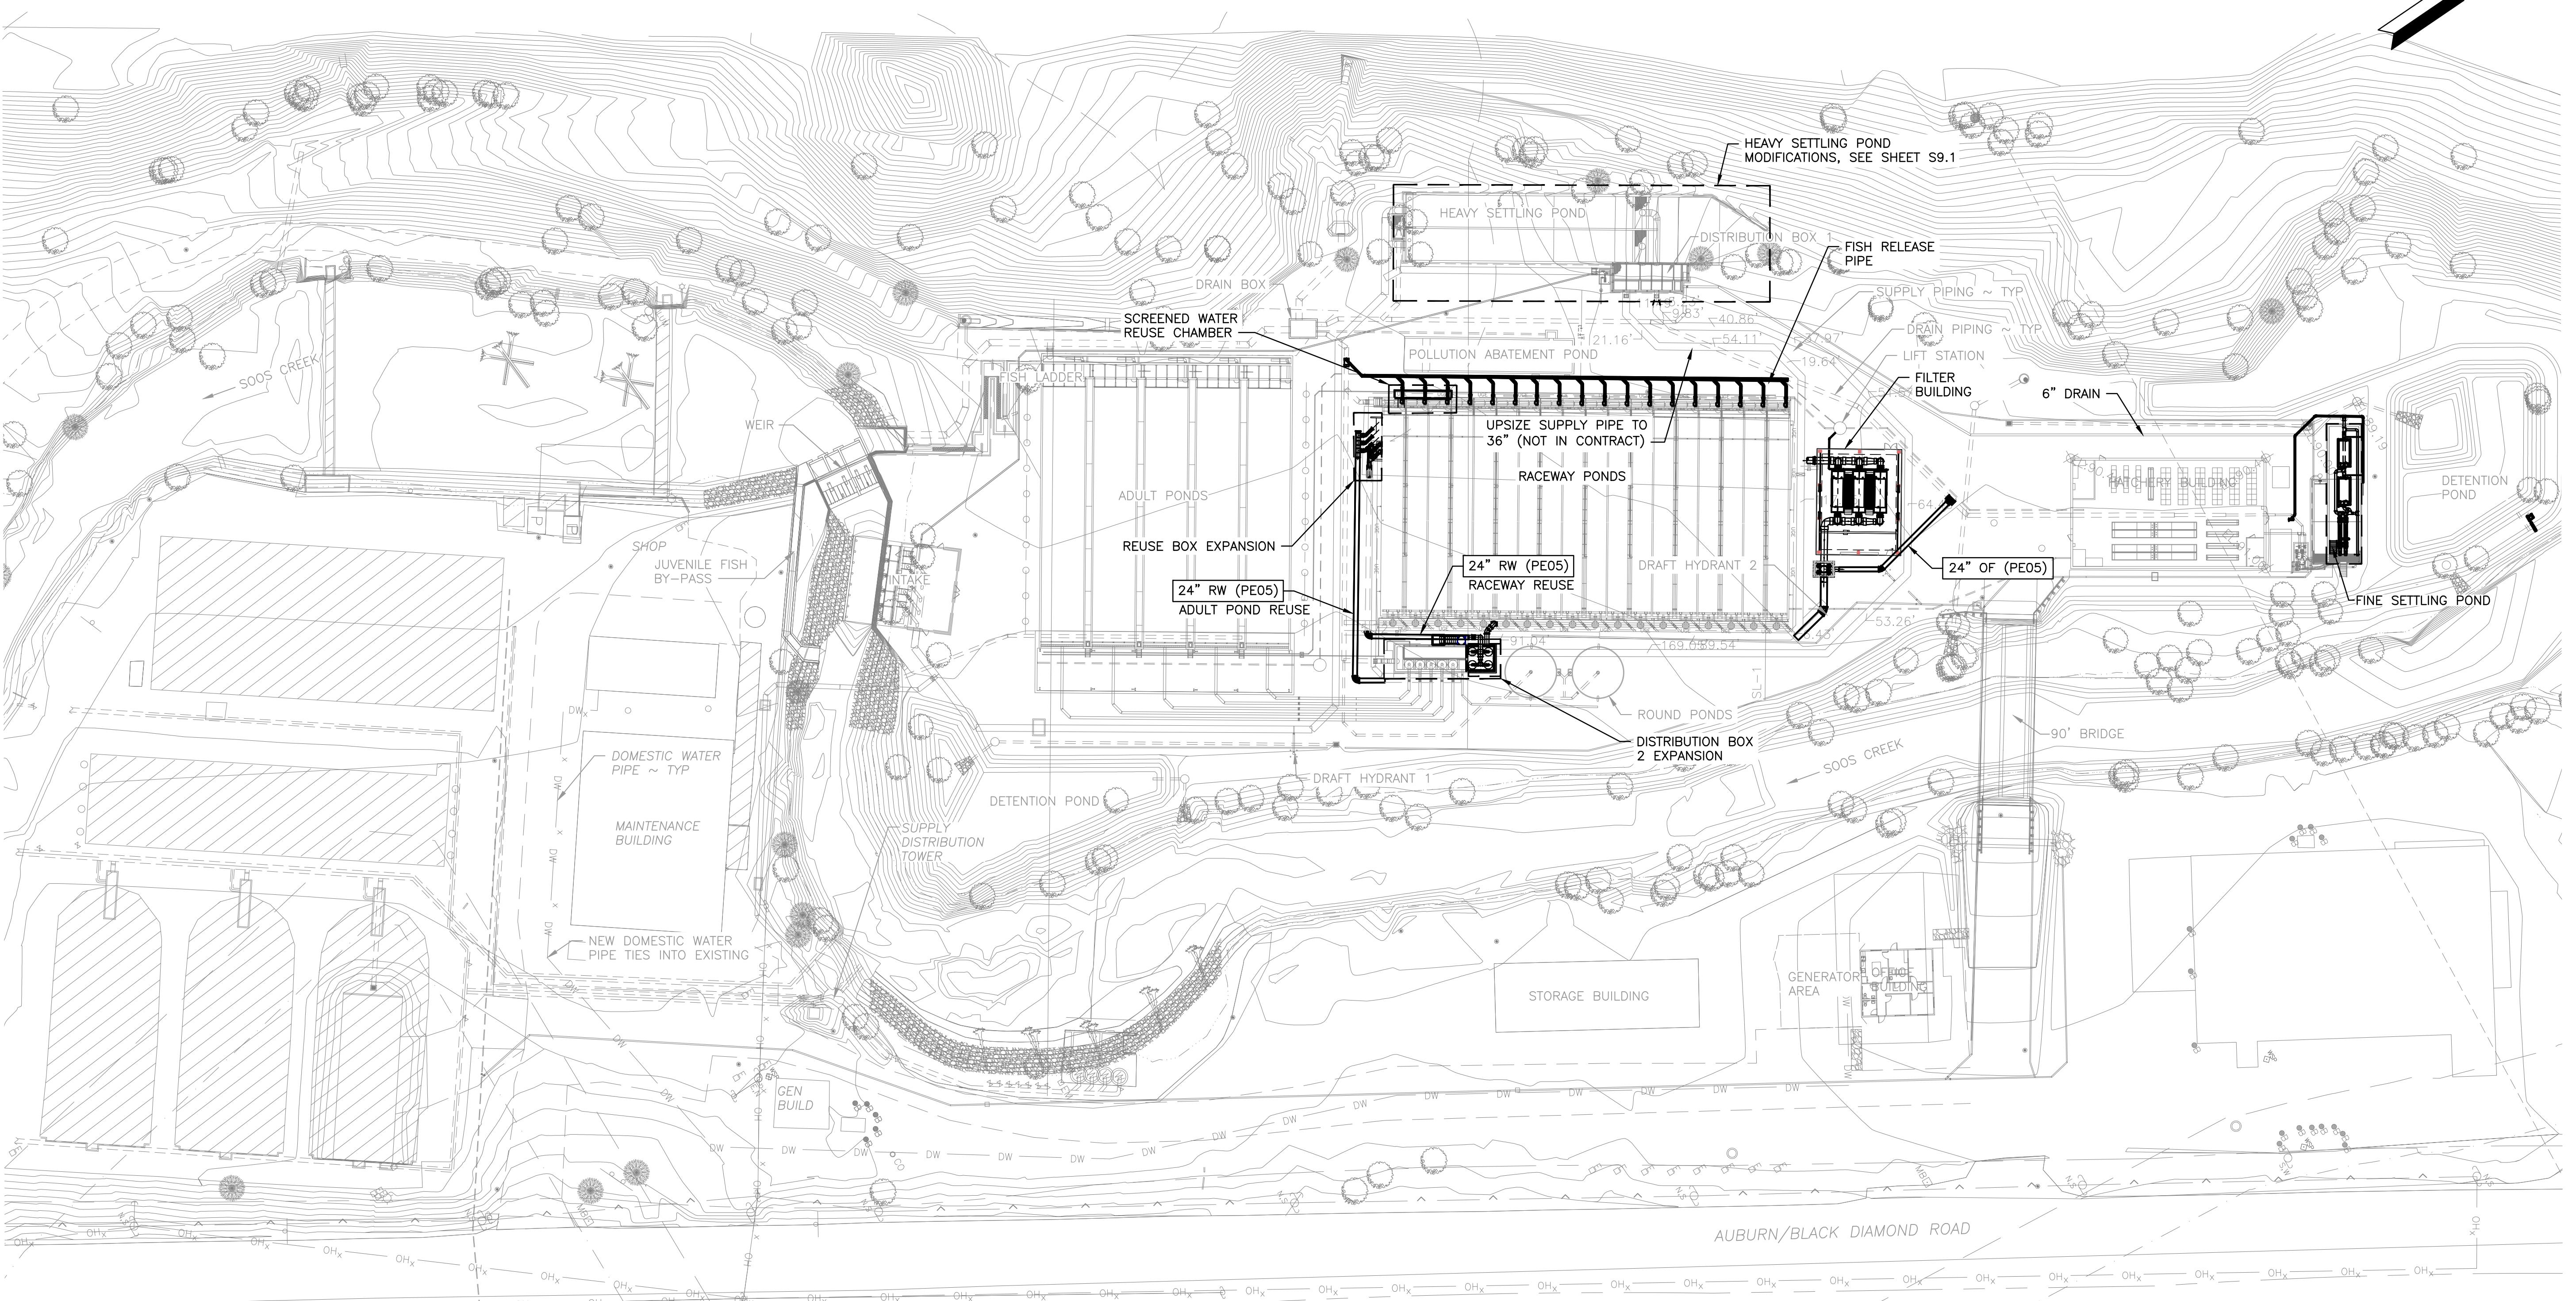

### SITE IMPROVEMENTS PLAN

SCALE: 1" = 40'



WASHINGTON DEPARTMENT OF  
FISH & WILDLIFE


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|---------------------------|------|--|--|---|-------------------------------------|
| SYM                       | DATE | REVISION DESCRIPTION                                     |  | BY  | DESIGNED BY D. WHITBECK             |
|                           |      | APPROVED AND RELEASED FOR CONSTRUCTION                   |  |   | CHECKED BY _____                    |
| CHIEF ENGINEER<br>PROGRAM |      |  |  |   | DRAWN BY STANTEC<br>DATE 05/17/2021 |

SOOS CREEK HATCHERY  
WATER SUPPLY TREATMENT  
PROJECT IMPROVEMENT  
SITE PLAN

DISCIPLINE SHEET #  
**G0.5**  
PROJECT NO.  
**XX:X##:###-#**  
SHEET 5 OF 74

WILSON  
SPRING

SOOS  
CREEK

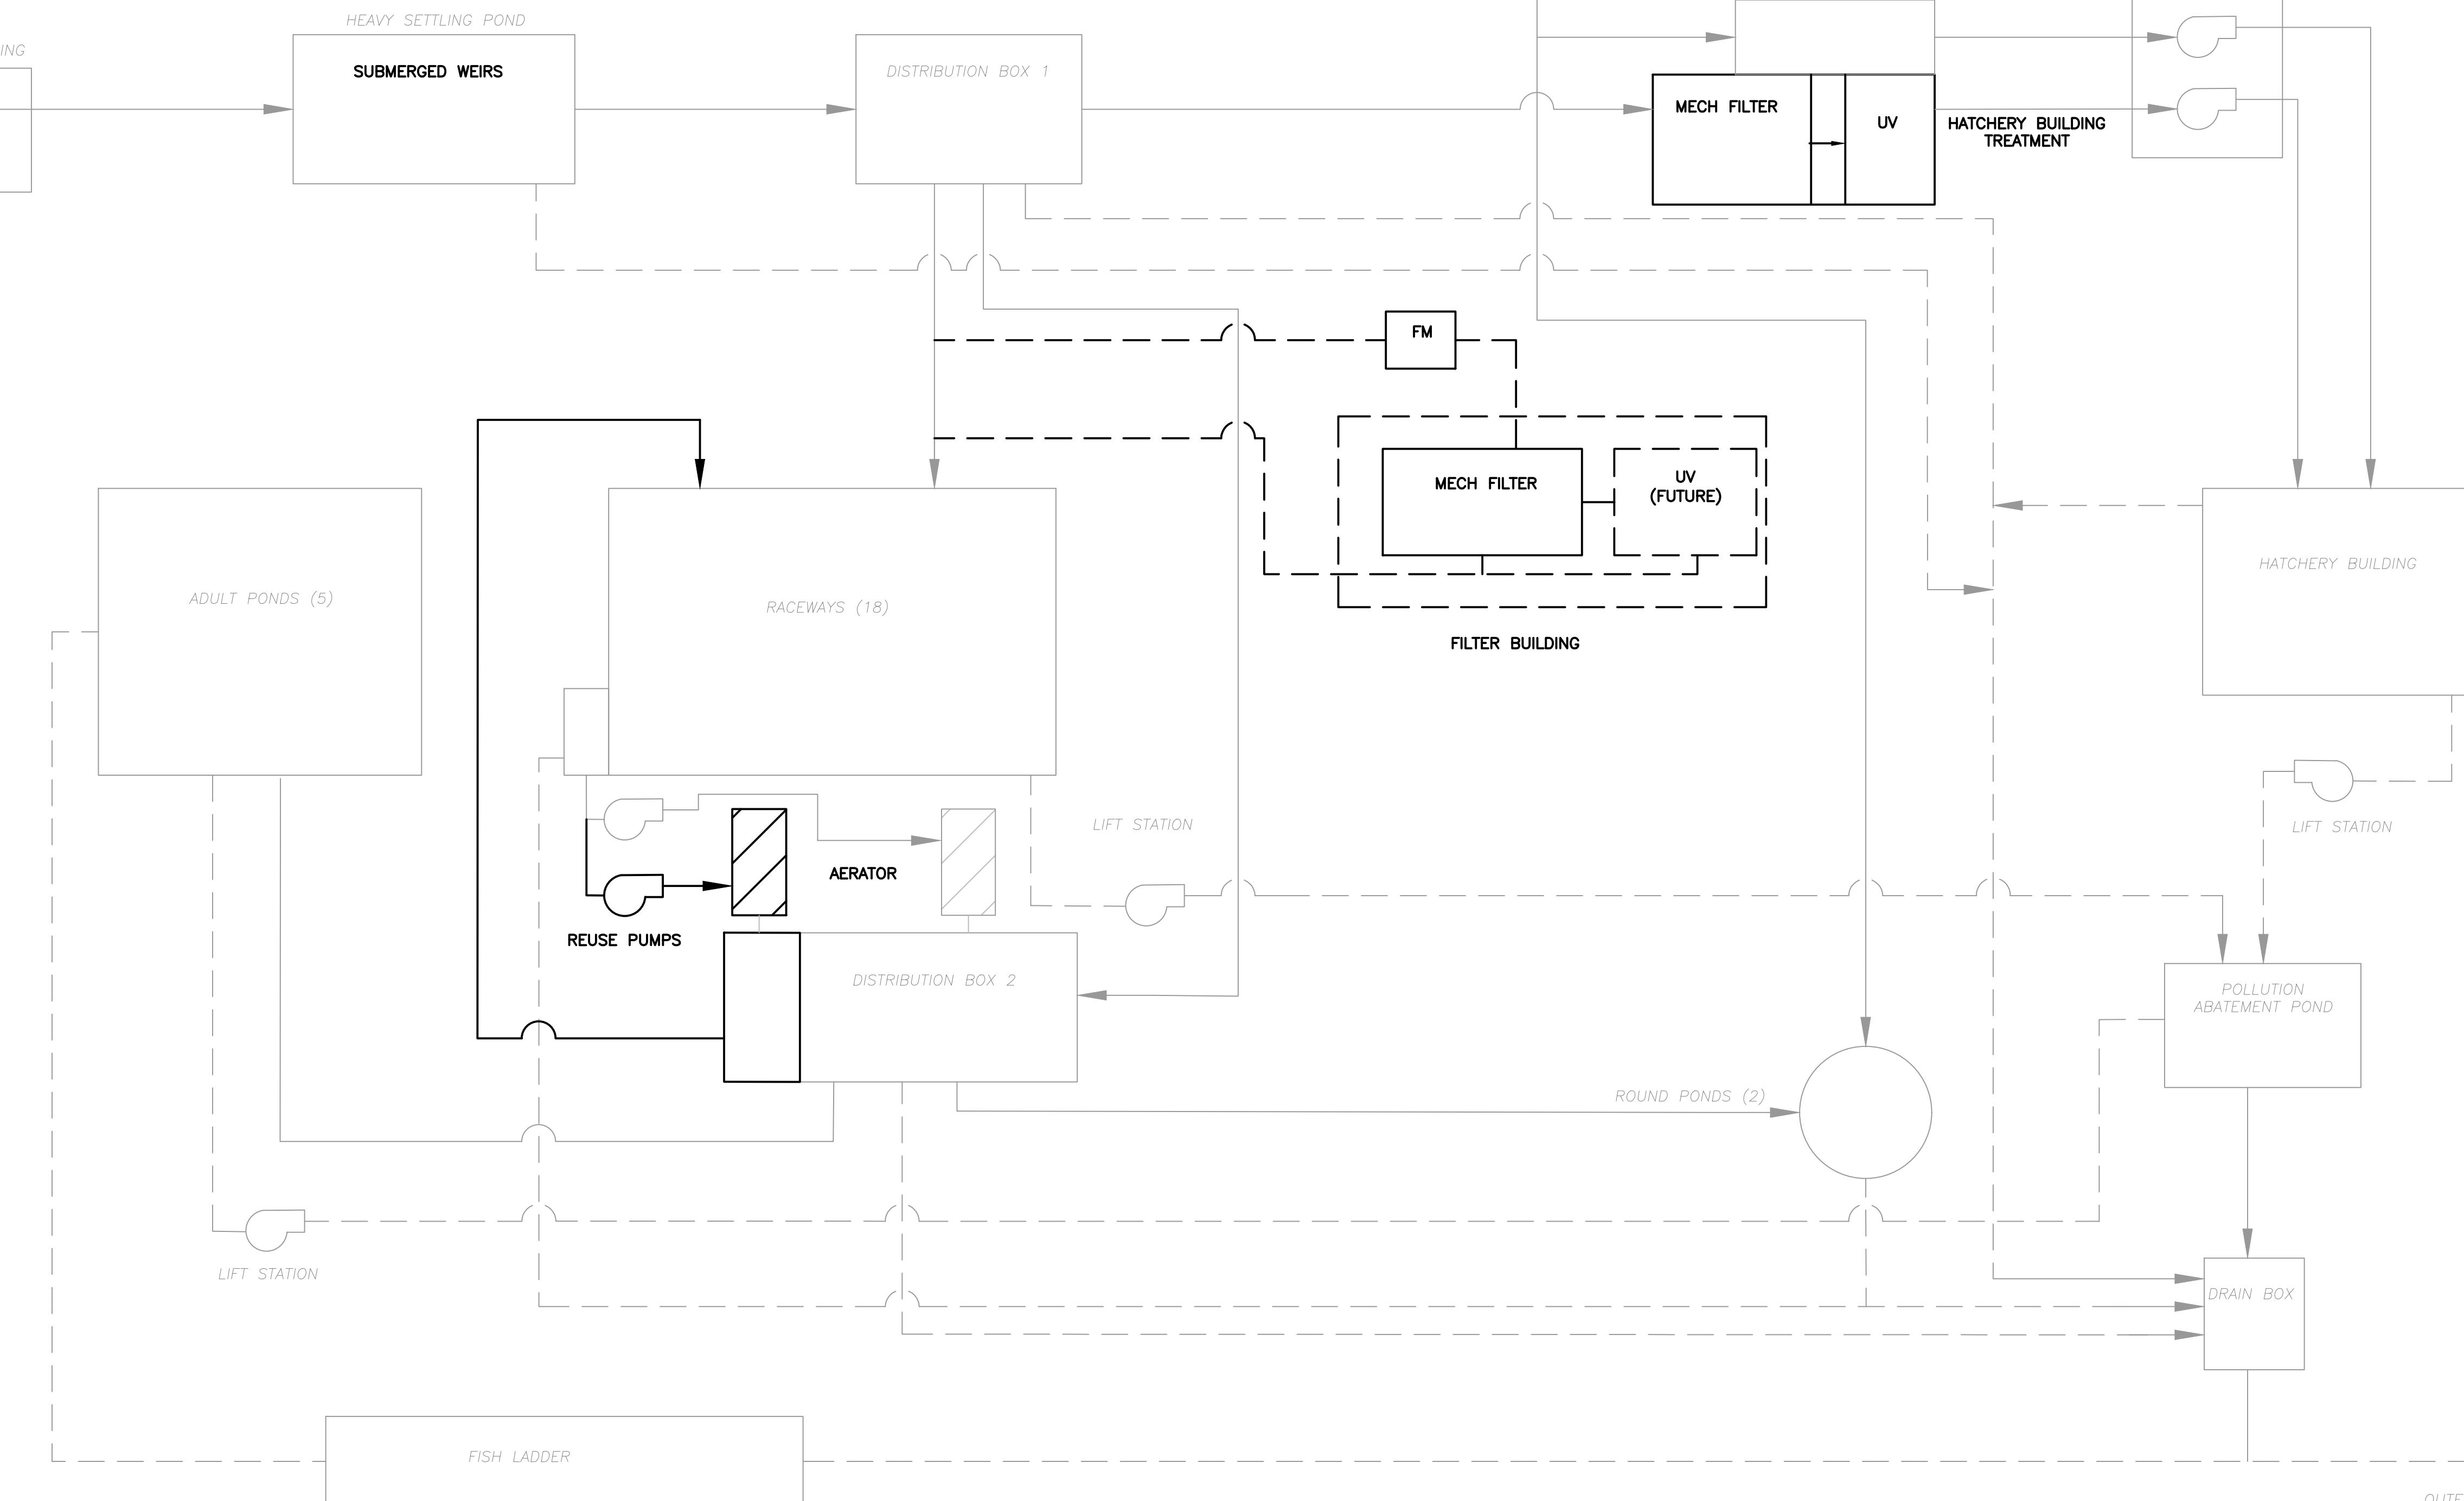

#### LEGEND

|       |                          |
|-------|--------------------------|
| —     | WATER SUPPLY             |
| - - - | DRAIN                    |
| UN    | ULTRAVIOLET DISINFECTION |
| ▲     | FLOW DIRECTION           |
| ❖     | VALVE, NORMALLY OPEN     |
| ■     | VALVE, NORMALLY CLOSED   |
| ●     | PUMP                     |
| □     | AERATOR                  |
| FM    | FLOW METER               |

OUTFALL TO SOOS CREEK

- NOTE:  
1. EXISTING PROCESS ELEMENTS ARE SHOWN SCREENED BACK.

DISCIPLINE SHEET #  
G0.9





WASHINGTON DEPARTMENT OF  
FISH & WILDLIFE

| SCHEMATIC DESIGN<br>NOT FOR CONSTRUCTION<br>MAY 17, 2021 |      | 0 — 1"   |
|--|------|--|
| SYM  | DATE | BAR MEASURES<br>ONE INCH ON<br>22x34 DRAWINGS                  |
|  |      | APPROVED AND RELEASED FOR CONSTRUCTION                         |
| CHIEF ENGINEER<br>PROGRAM                                |      | DESIGNED BY D. WHITBECK<br>DRAWN BY STANTEC<br>DATE 05/17/2021 |

SOOS CREEK HATCHERY  
WATER SUPPLY TREATMENT  
PROCESS FLOW DIAGRAM

PROJECT NO.  
XX:X##:###-#  
SHEET 9 OF 74

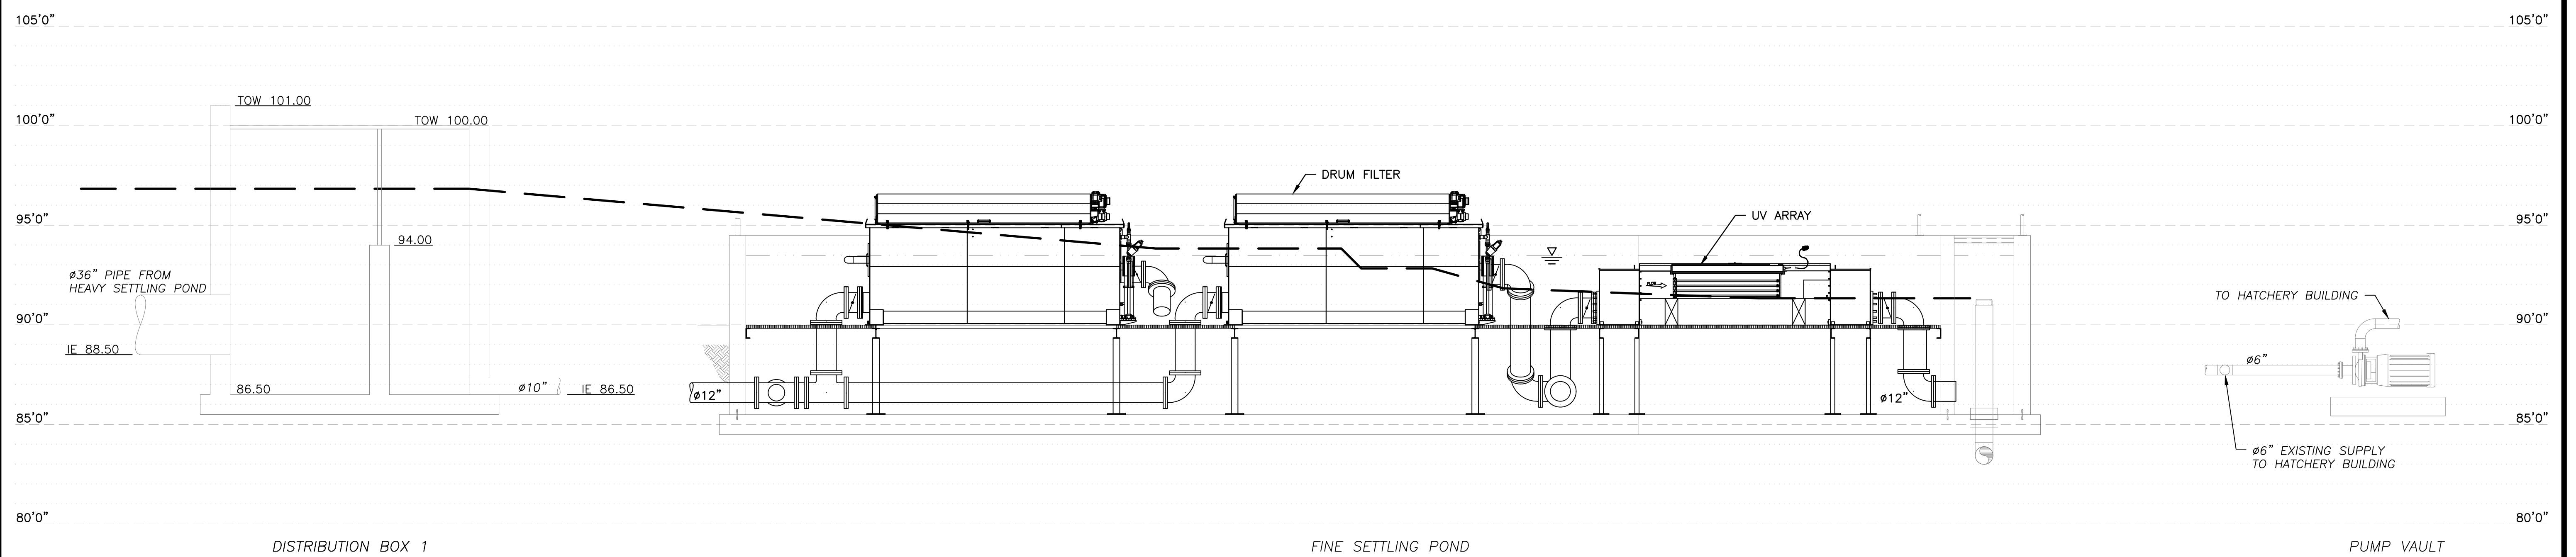
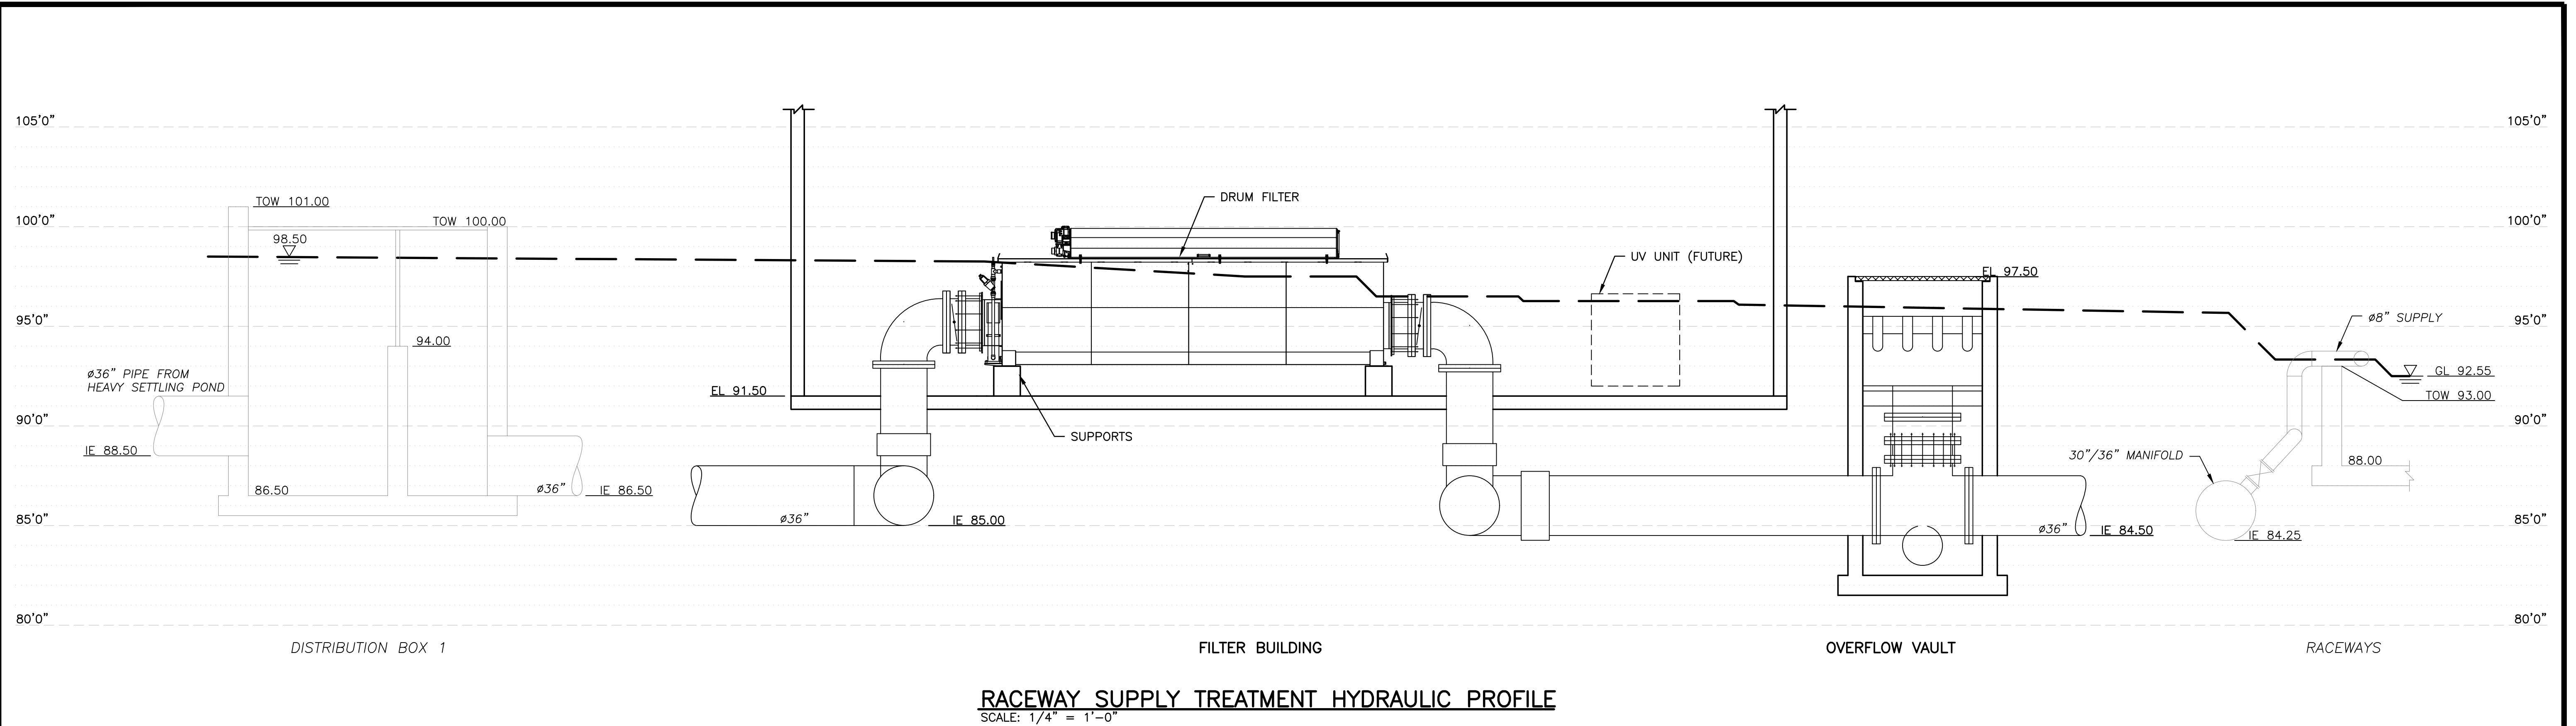


WASHINGTON DEPARTMENT OF  
FISH & WILDLIFE

|                           |      | SCHEMATIC DESIGN<br>NOT FOR CONSTRUCTION<br>MAY 17, 2021 |  | 0 — 1"<br>BAR MEASURES<br>ONE INCH ON<br>22x34 DRAWINGS |
|---------------------------|------|--|--|---|
| SYM                       | DATE | REVISION DESCRIPTION                                     |  |   |
|                           |      | APPROVED AND RELEASED FOR CONSTRUCTION                   |  | DESIGNED BY D. WHITBECK                                 |
| CHIEF ENGINEER<br>PROGRAM |      |  |  | CHECKED BY _____<br>DRAWN BY STANTEC<br>DATE 05/17/2021 |

SOOS CREEK HATCHERY  
WATER SUPPLY TREATMENT  
HYDRAULIC PROFILES

DISCIPLINE SHEET #  
**G0.10**  
PROJECT NO.  
XX:X##:###-#  
SHEET 10 OF 74

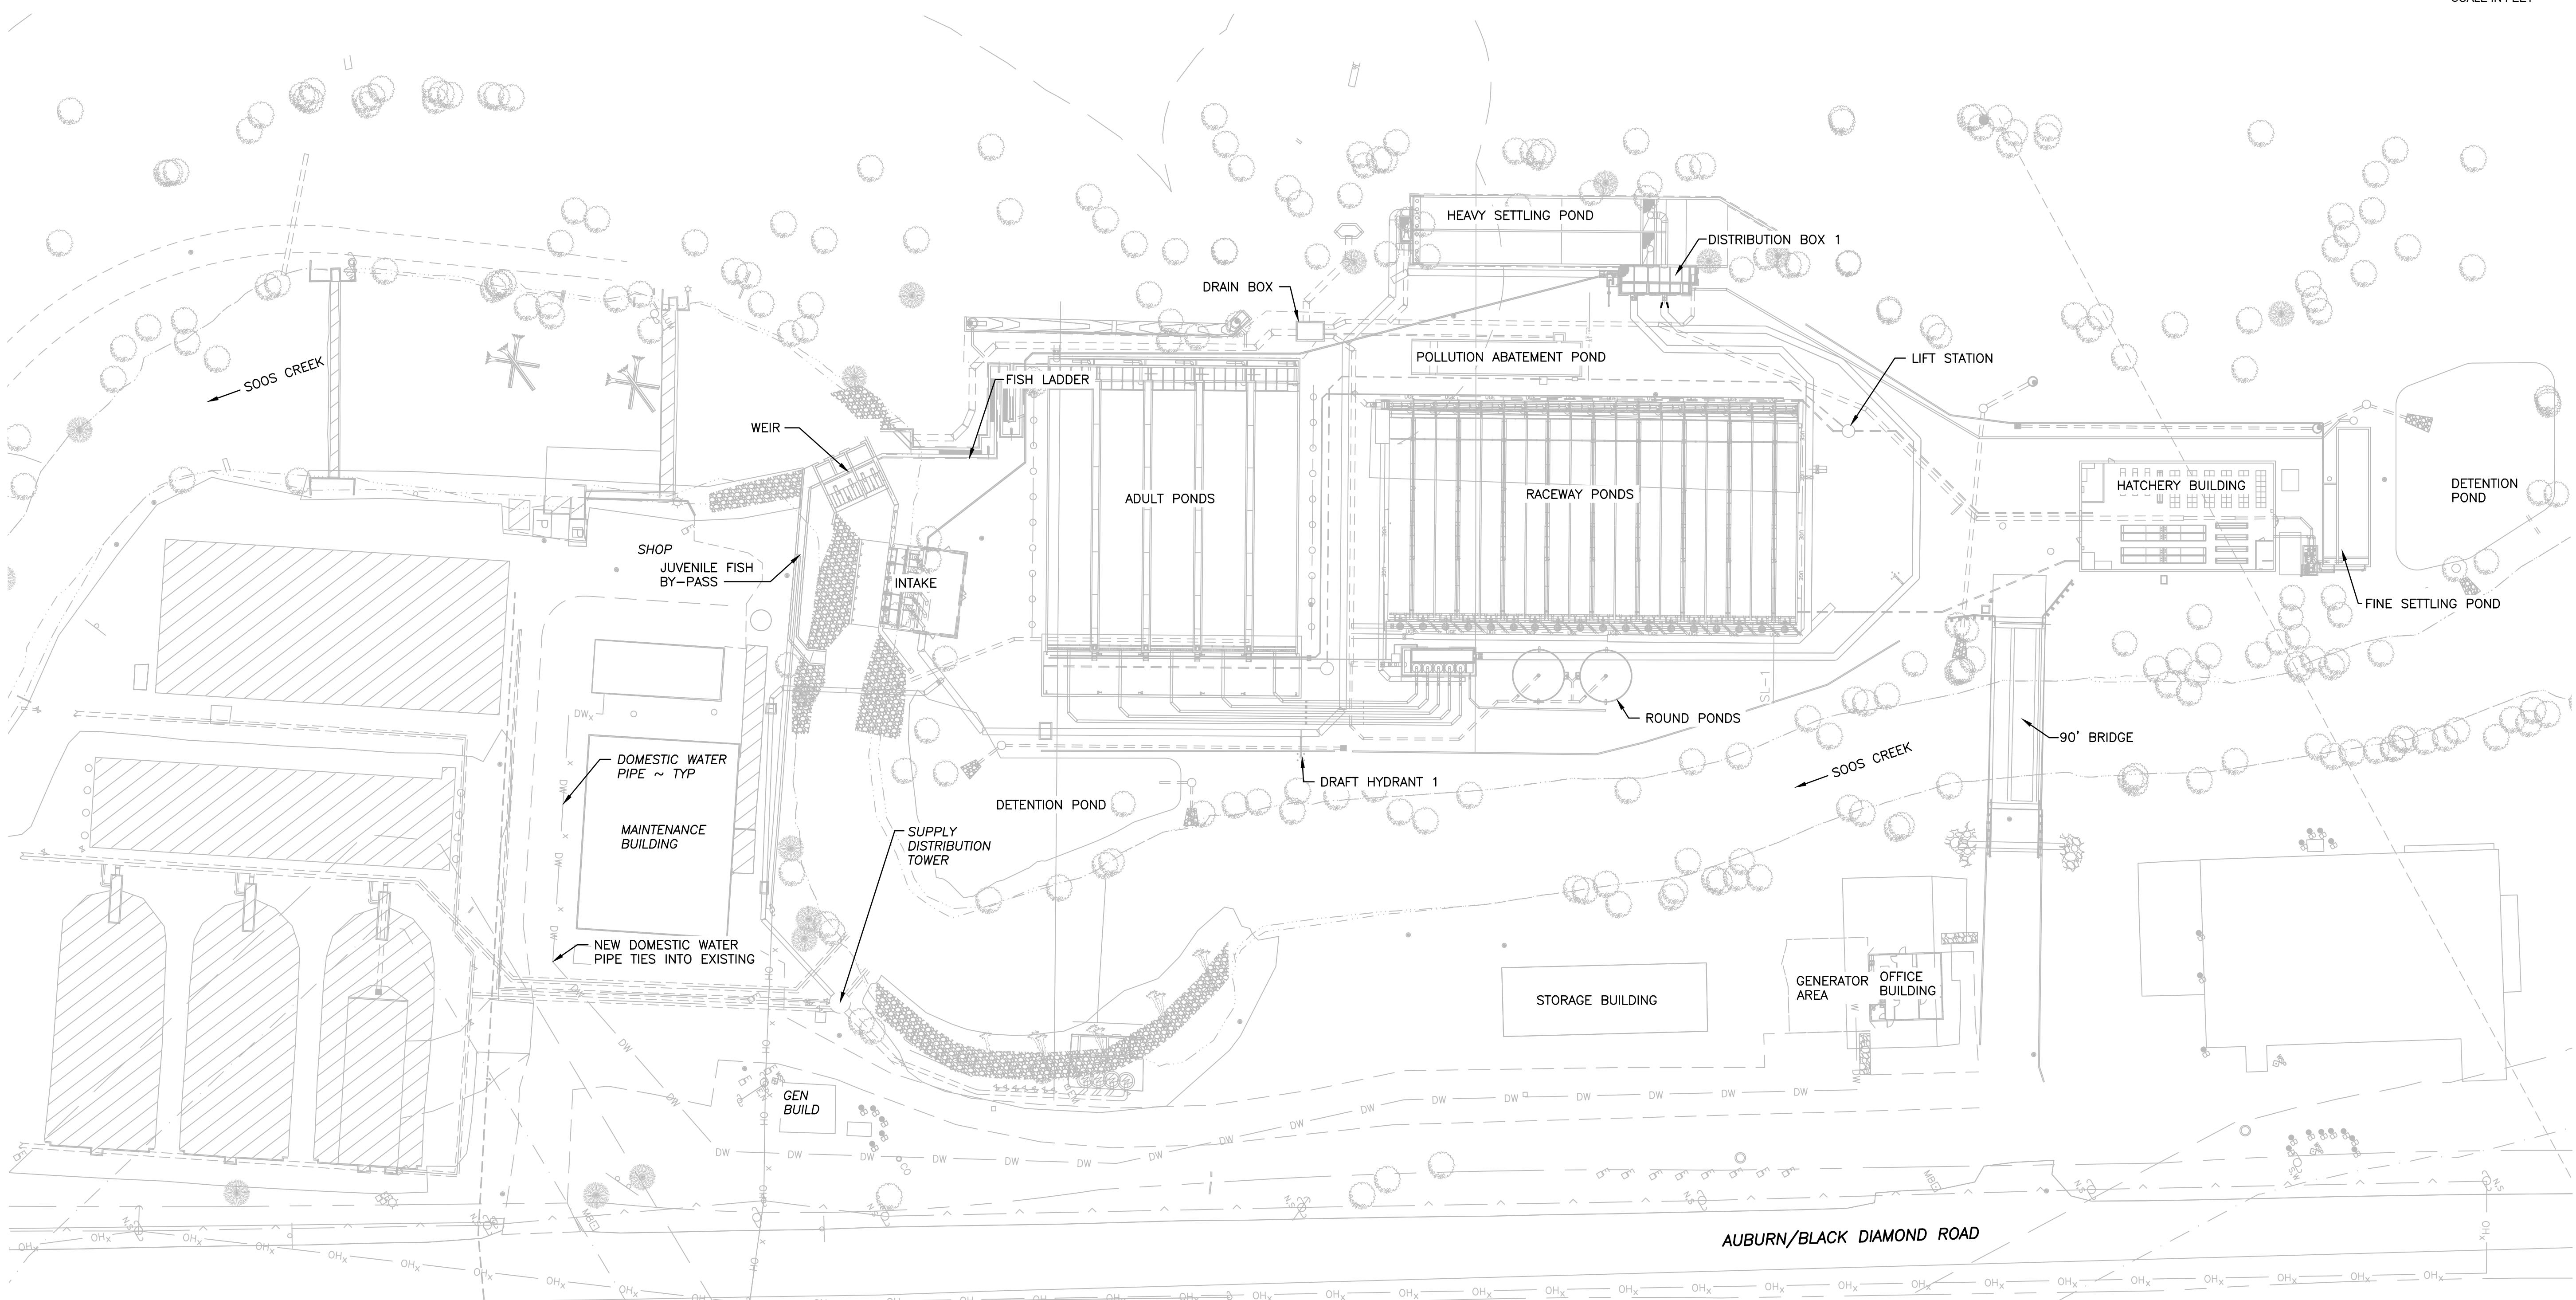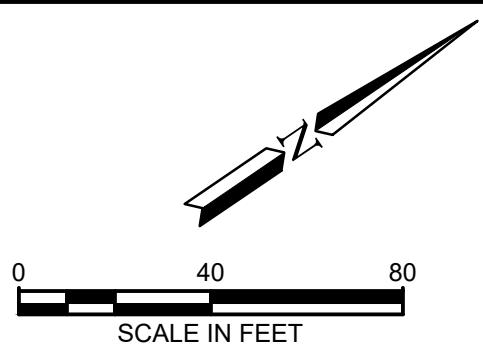

**SITE PLAN**

SCALE: 1" = 40'



**WASHINGTON DEPARTMENT OF  
FISH & WILDLIFE**



| SYM                                    | DATE | REVISION DESCRIPTION | BY                  |
|--|------|----------------------|---------------------|
| APPROVED AND RELEASED FOR CONSTRUCTION |      |                      |                     |
| CHIEF ENGINEER                         |      | DATE:                | DESIGNED BY F. LAST |
| PROGRAM                                |      | DATE:                | CHECKED BY F. LAST  |

**SOOS CREEK HATCHERY  
WATER SUPPLY TREATMENT  
PROJECT IMPROVEMENT  
SITE PLAN**

DISCIPLINE SHEET #  
**C1.1**

PROJECT NO.  
**XX:X#######-**

SHEET **16** OF **74**

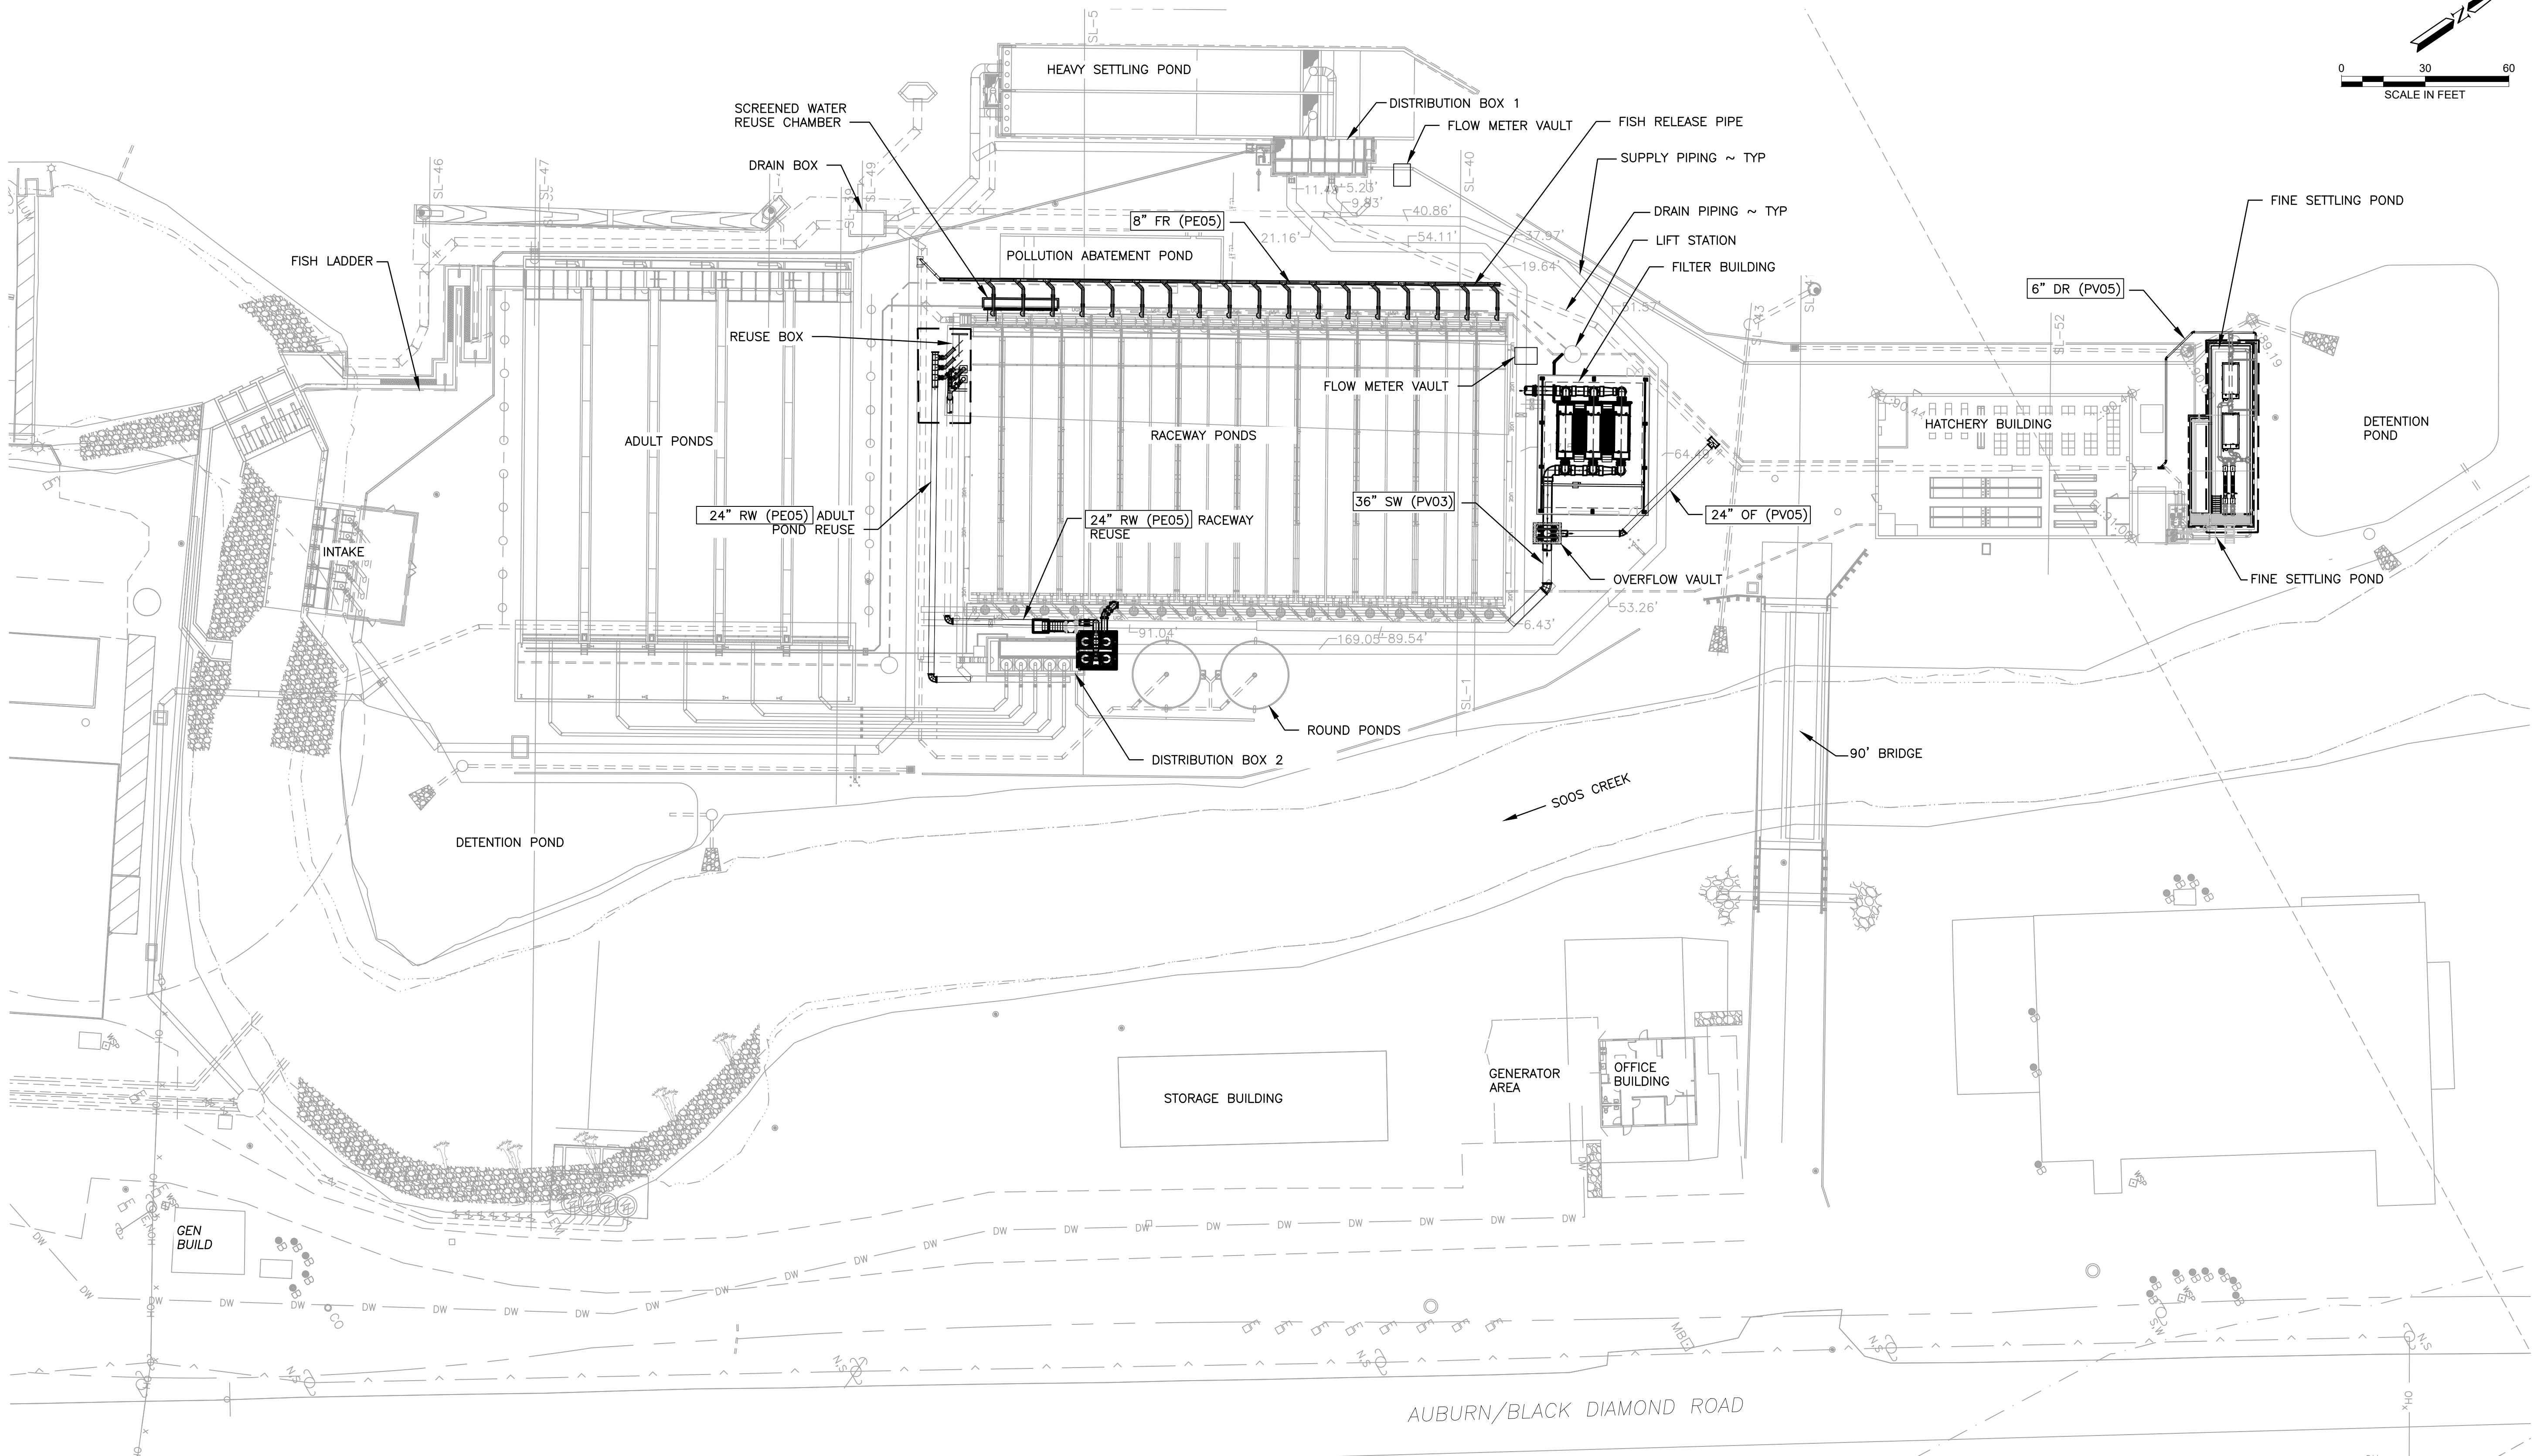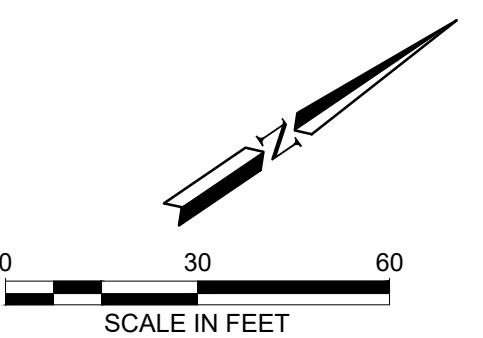

**SITE PIPING PLAN**  
SCALE: 1" = 30'





WASHINGTON DEPARTMENT OF  
**FISH & WILDLIFE**

| SYM                                    | DATE  | REVISION DESCRIPTION | BY                  |
|--|-------|----------------------|---------------------|
| APPROVED AND RELEASED FOR CONSTRUCTION |       |                      |                     |
| CHIEF ENGINEER .....                   | ..... | DATE: .....          | DESIGNED BY F. LAST |
| PROGRAM .....                          | ..... | DATE: .....          | CHECKED BY F. LAST  |

**SOOS CREEK HATCHERY**  
**WATER SUPPLY TREATMENT**  
PROJECT IMPROVEMENT  
SITE PIPING PLAN

DISCIPLINE SHEET #  
**C2.1**  
PROJECT NO.  
XX:X##:###-#  
SHEET 18 OF 74

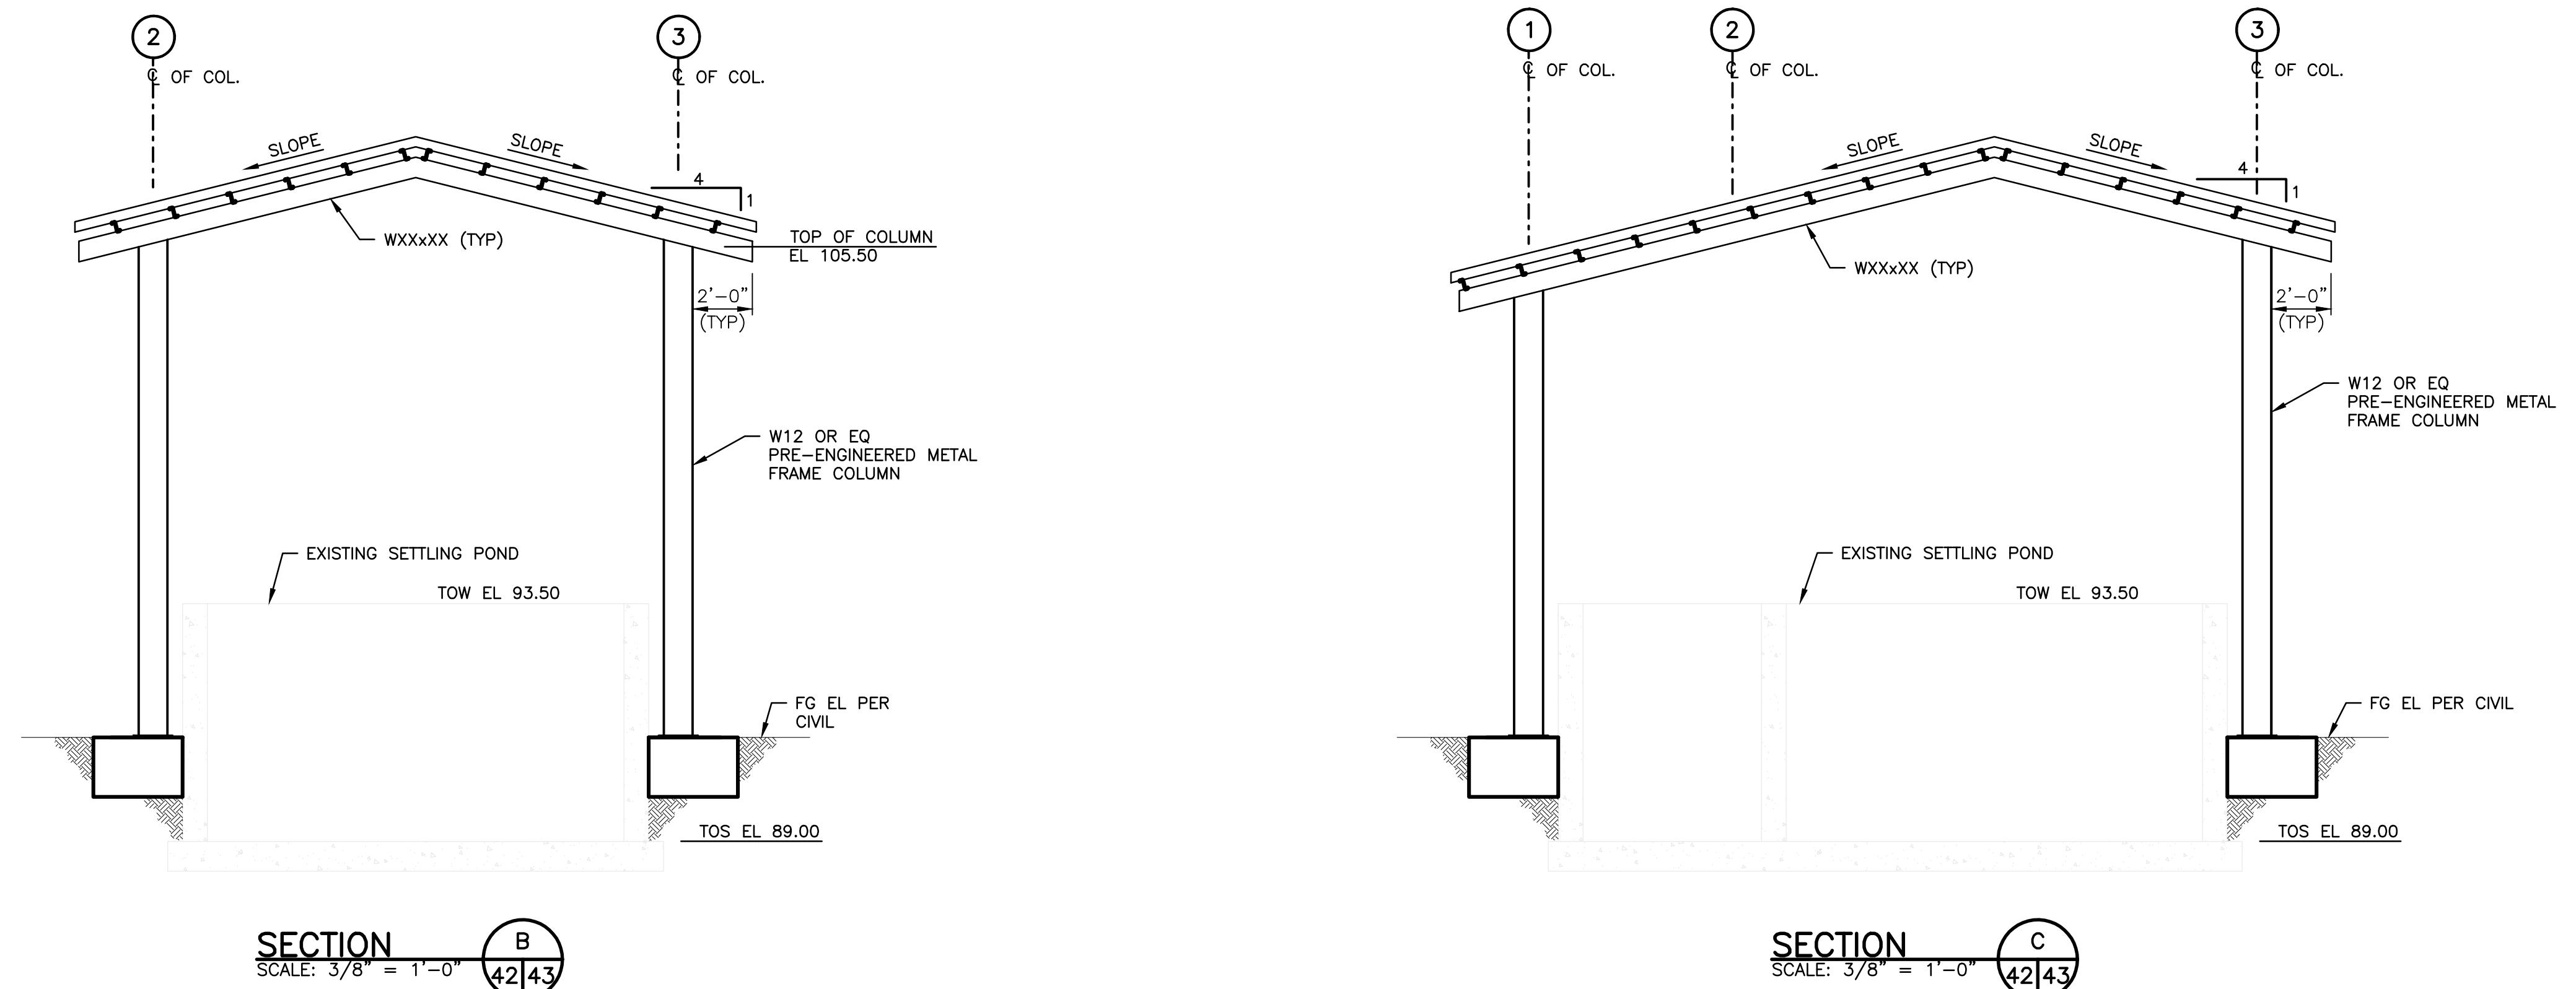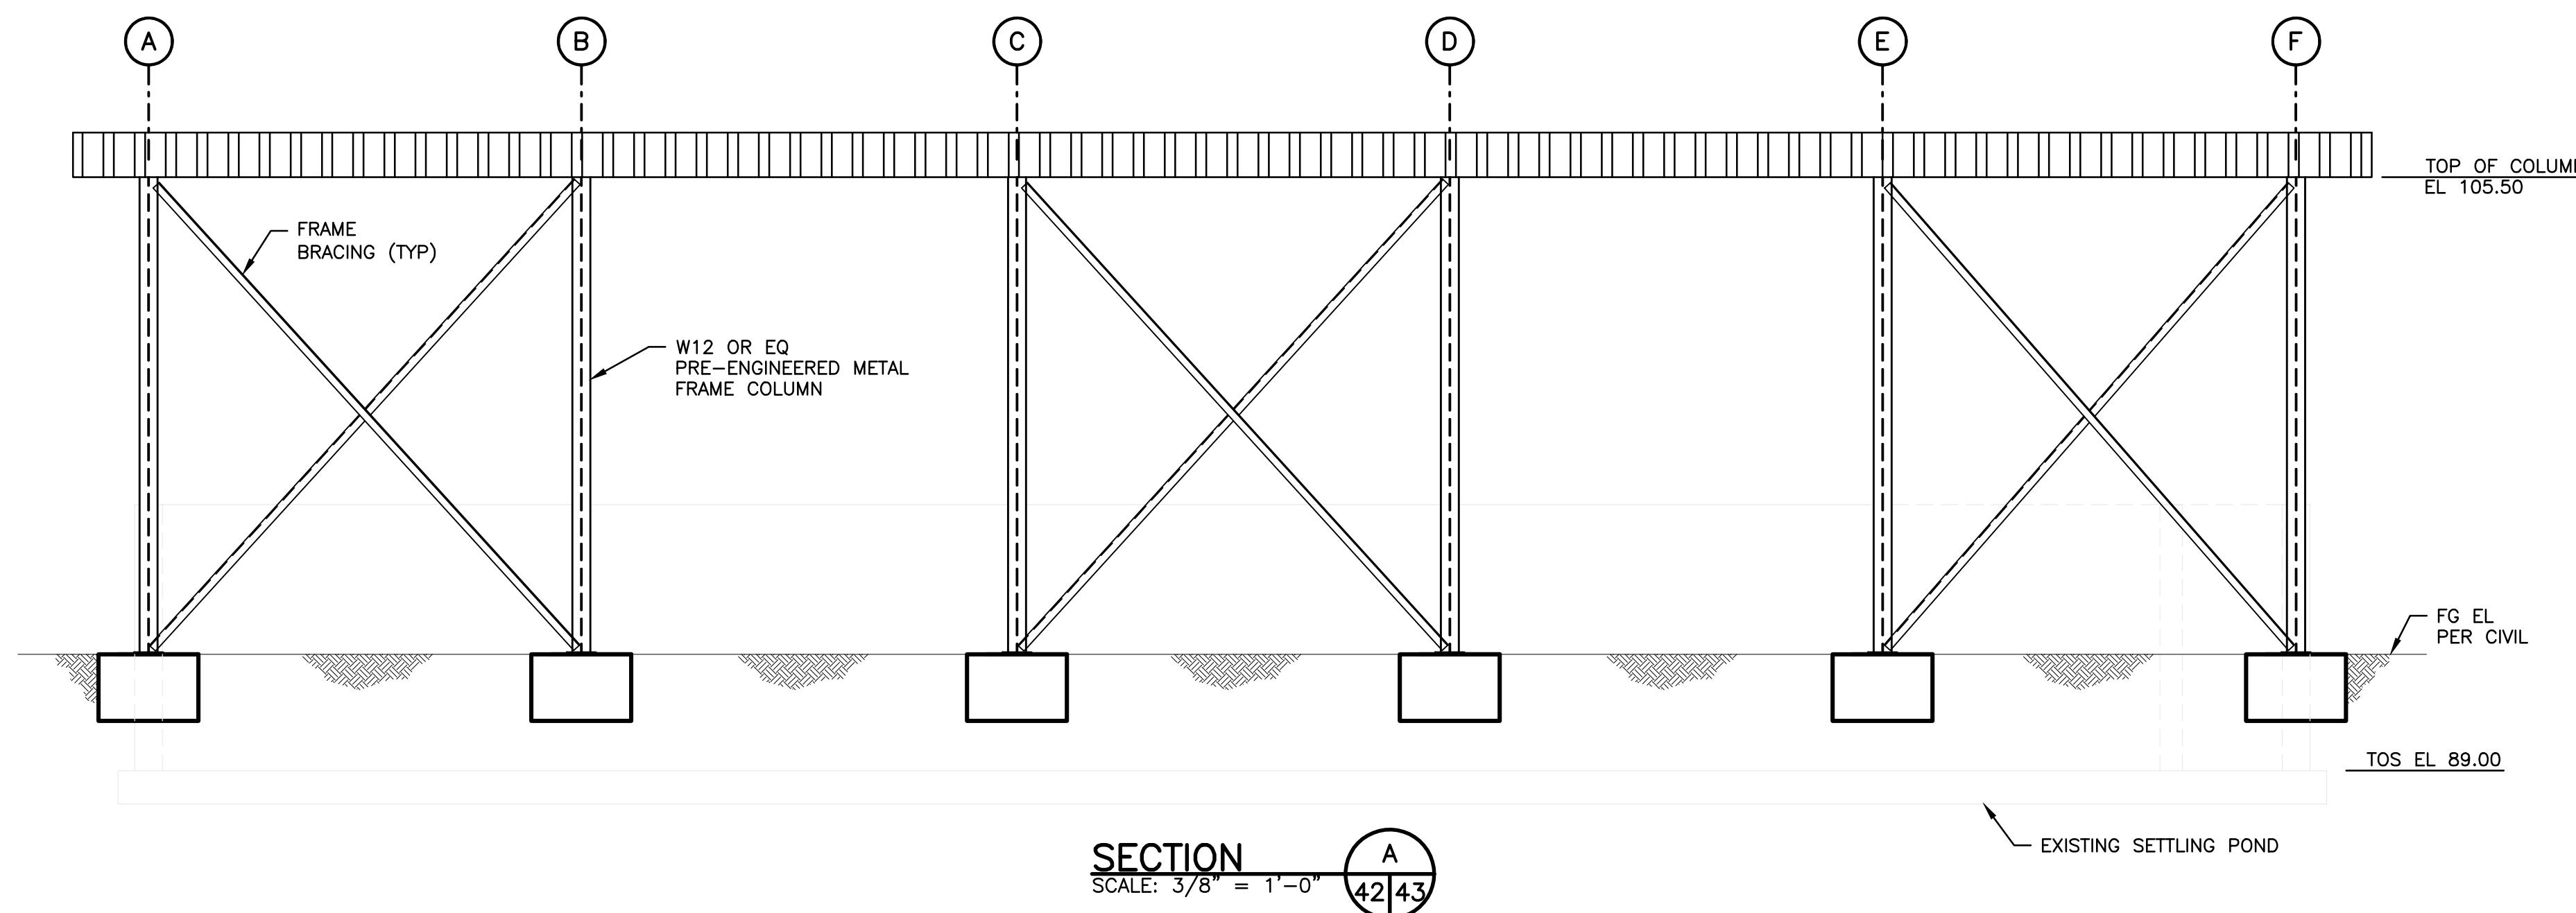

WASHINGTON DEPARTMENT OF  
FISH & WILDLIFE

SCHEMATIC DESIGN  
NOT FOR CONSTRUCTION  
MAY 17, 2021

APPROVED AND RELEASED FOR CONSTRUCTION

CHIEF ENGINEER ..... DATE: ..... DATE: .....  
PROGRAM ..... DATE: ..... DATE: .....

0 \_\_\_\_\_ 1"  
BAR MEASURES  
ONE INCH ON  
22x34 DRAWINGS

DESIGNED BY F. LAST  
CHECKED BY F. LAST

DRAWN BY S. NADKAR  
DATE MM/DD/YYYY

SOOS CREEK HATCHERY  
WATER SUPPLY TREATMENT  
FINE SETTLING POND  
STRUCTURAL SECTIONS AND DETAILS

DISCIPLINE SHEET #  
**S12.2**

PROJECT NO.


XX:X##:###-#

SHEET

**43**



OF

**74**

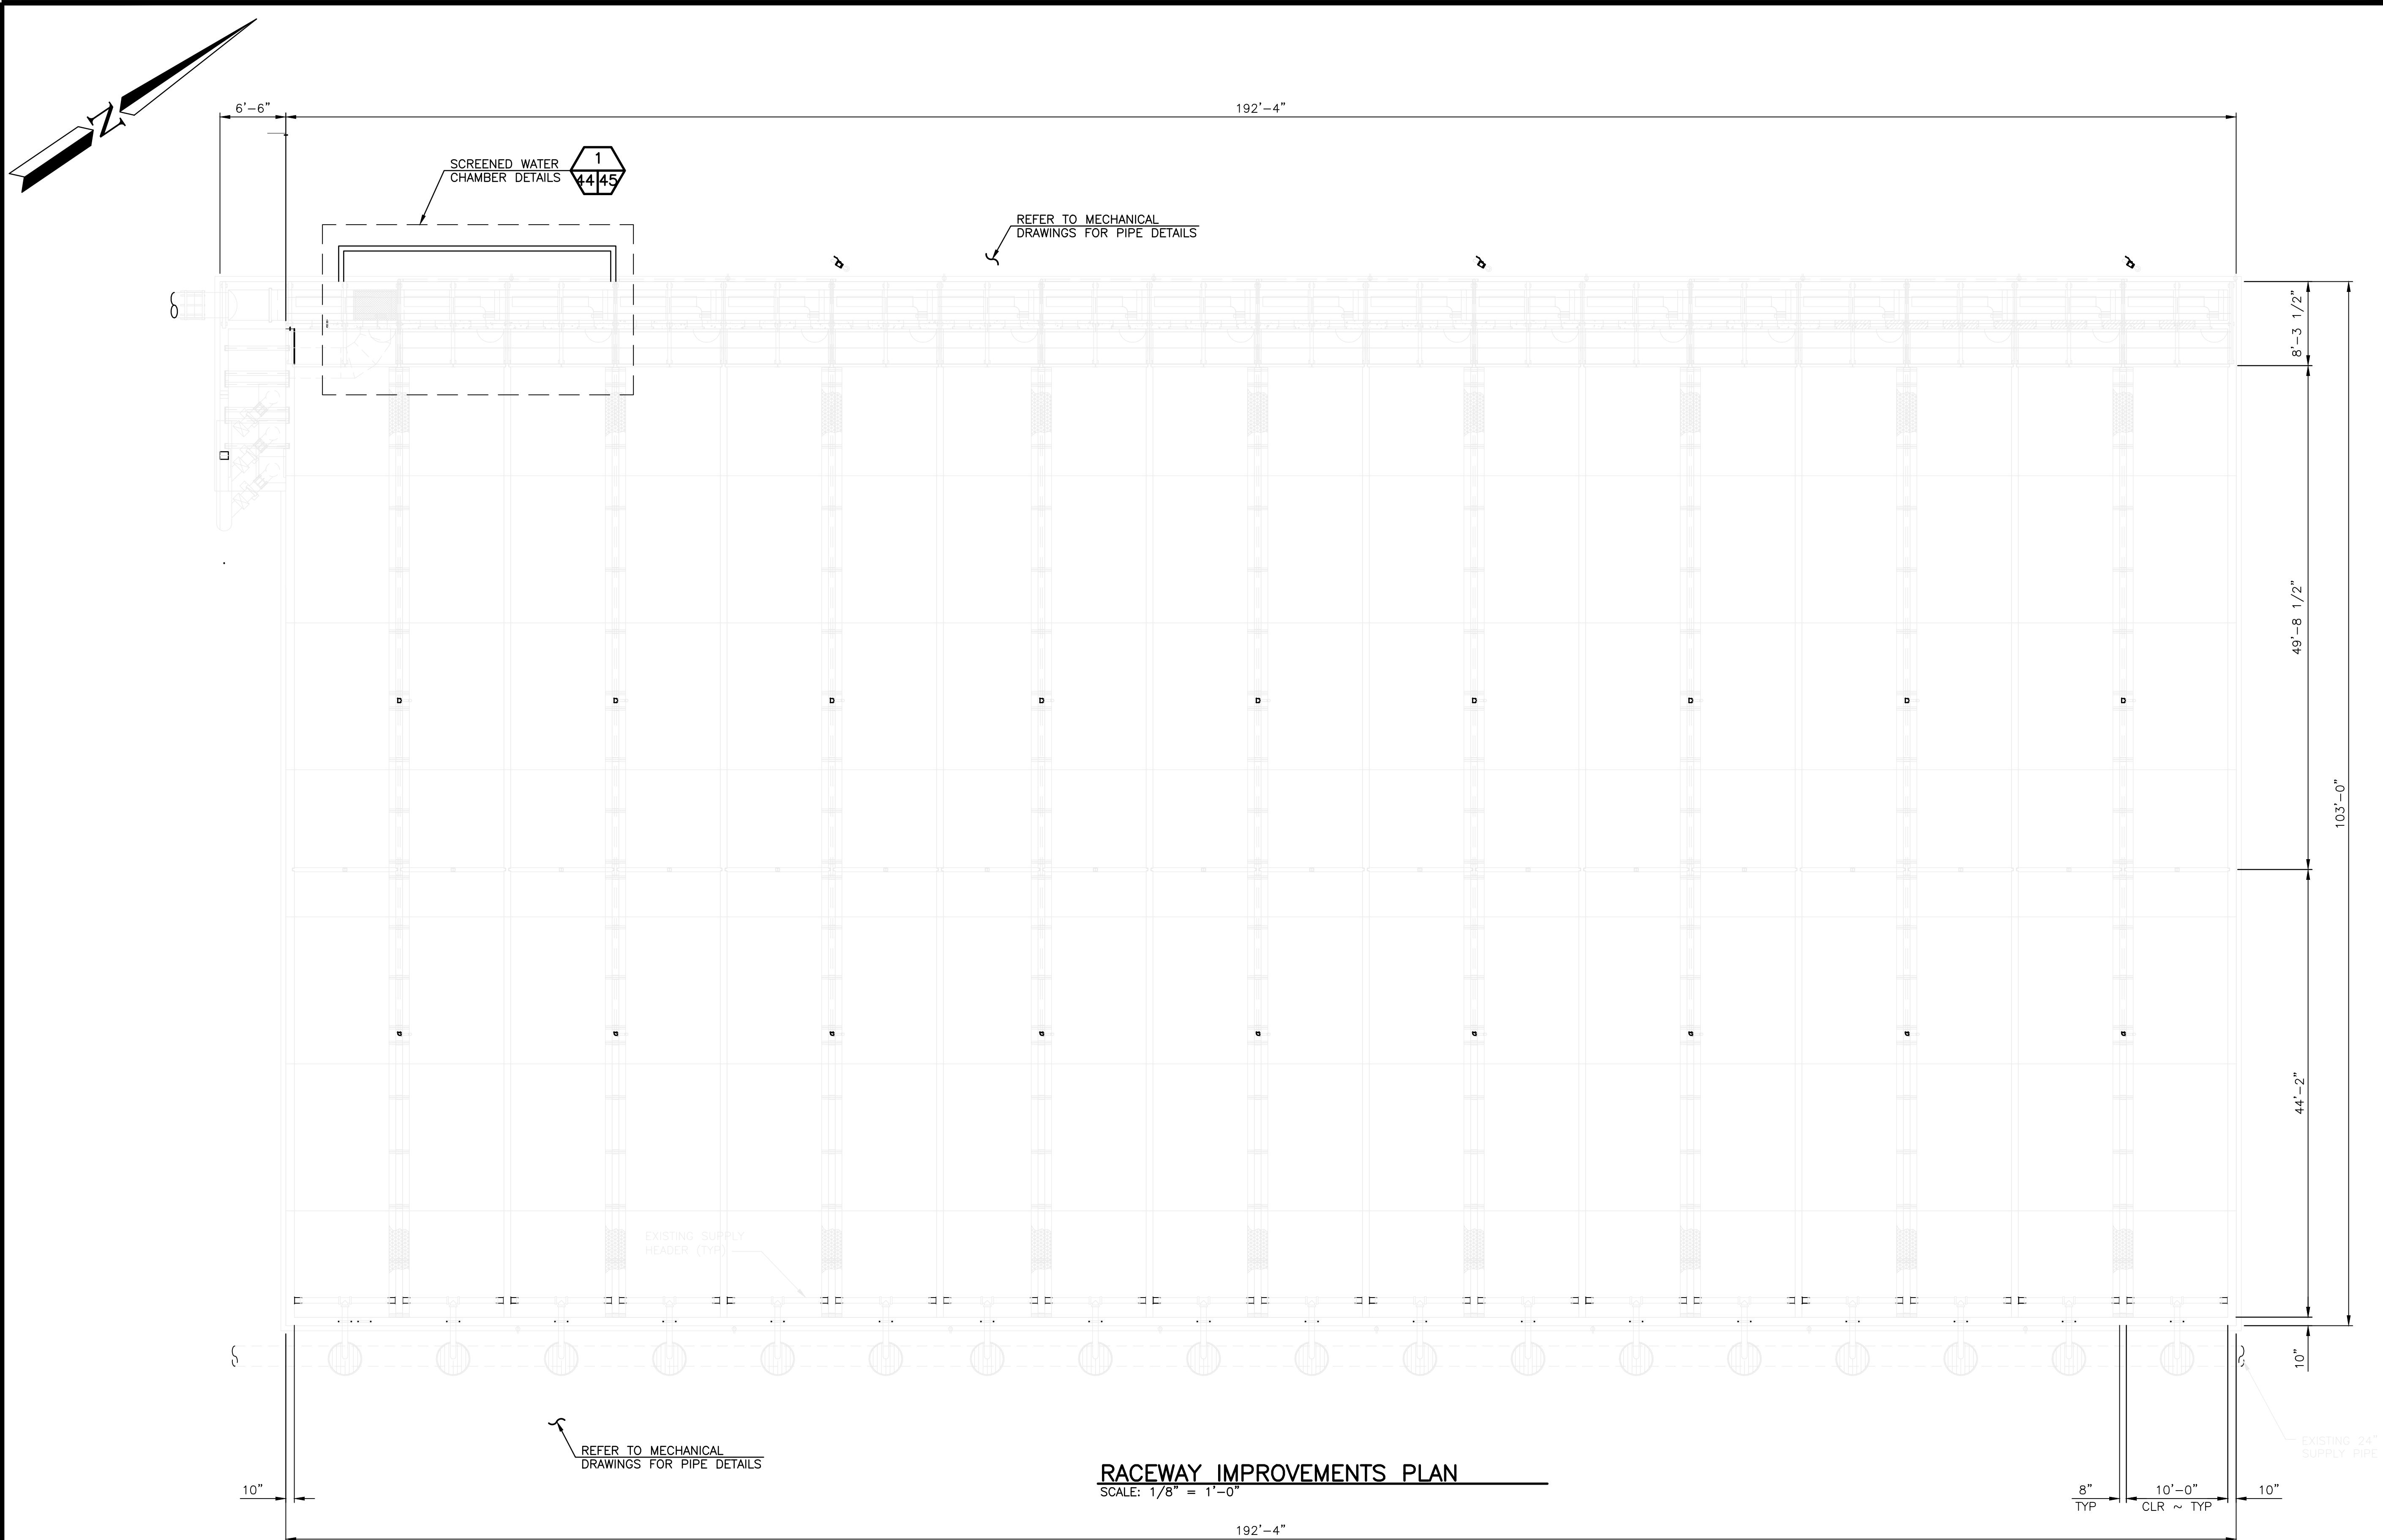


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|  | WASHINGTON DEPARTMENT OF<br>FISH & WILDLIFE |  | SCHEMATIC DESIGN<br>NOT FOR CONSTRUCTION<br>MAY 17, 2021 |      |                      |    | 0 — 1"<br>BAR MEASURES<br>ONE INCH ON<br>22x34 DRAWINGS | SOOS CREEK HATCHERY<br>WATER SUPPLY TREATMENT<br>RACEWAY IMPROVEMENTS PLAN | DISCIPLINE SHEET # |              |
|  |   |  | SYM  | DATE | REVISION DESCRIPTION | BY |   |  | PROJECT NO.        | XX:X##:###-# |

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## SCREENED WATER CHAMBER DETAIL – PLAN VIEW

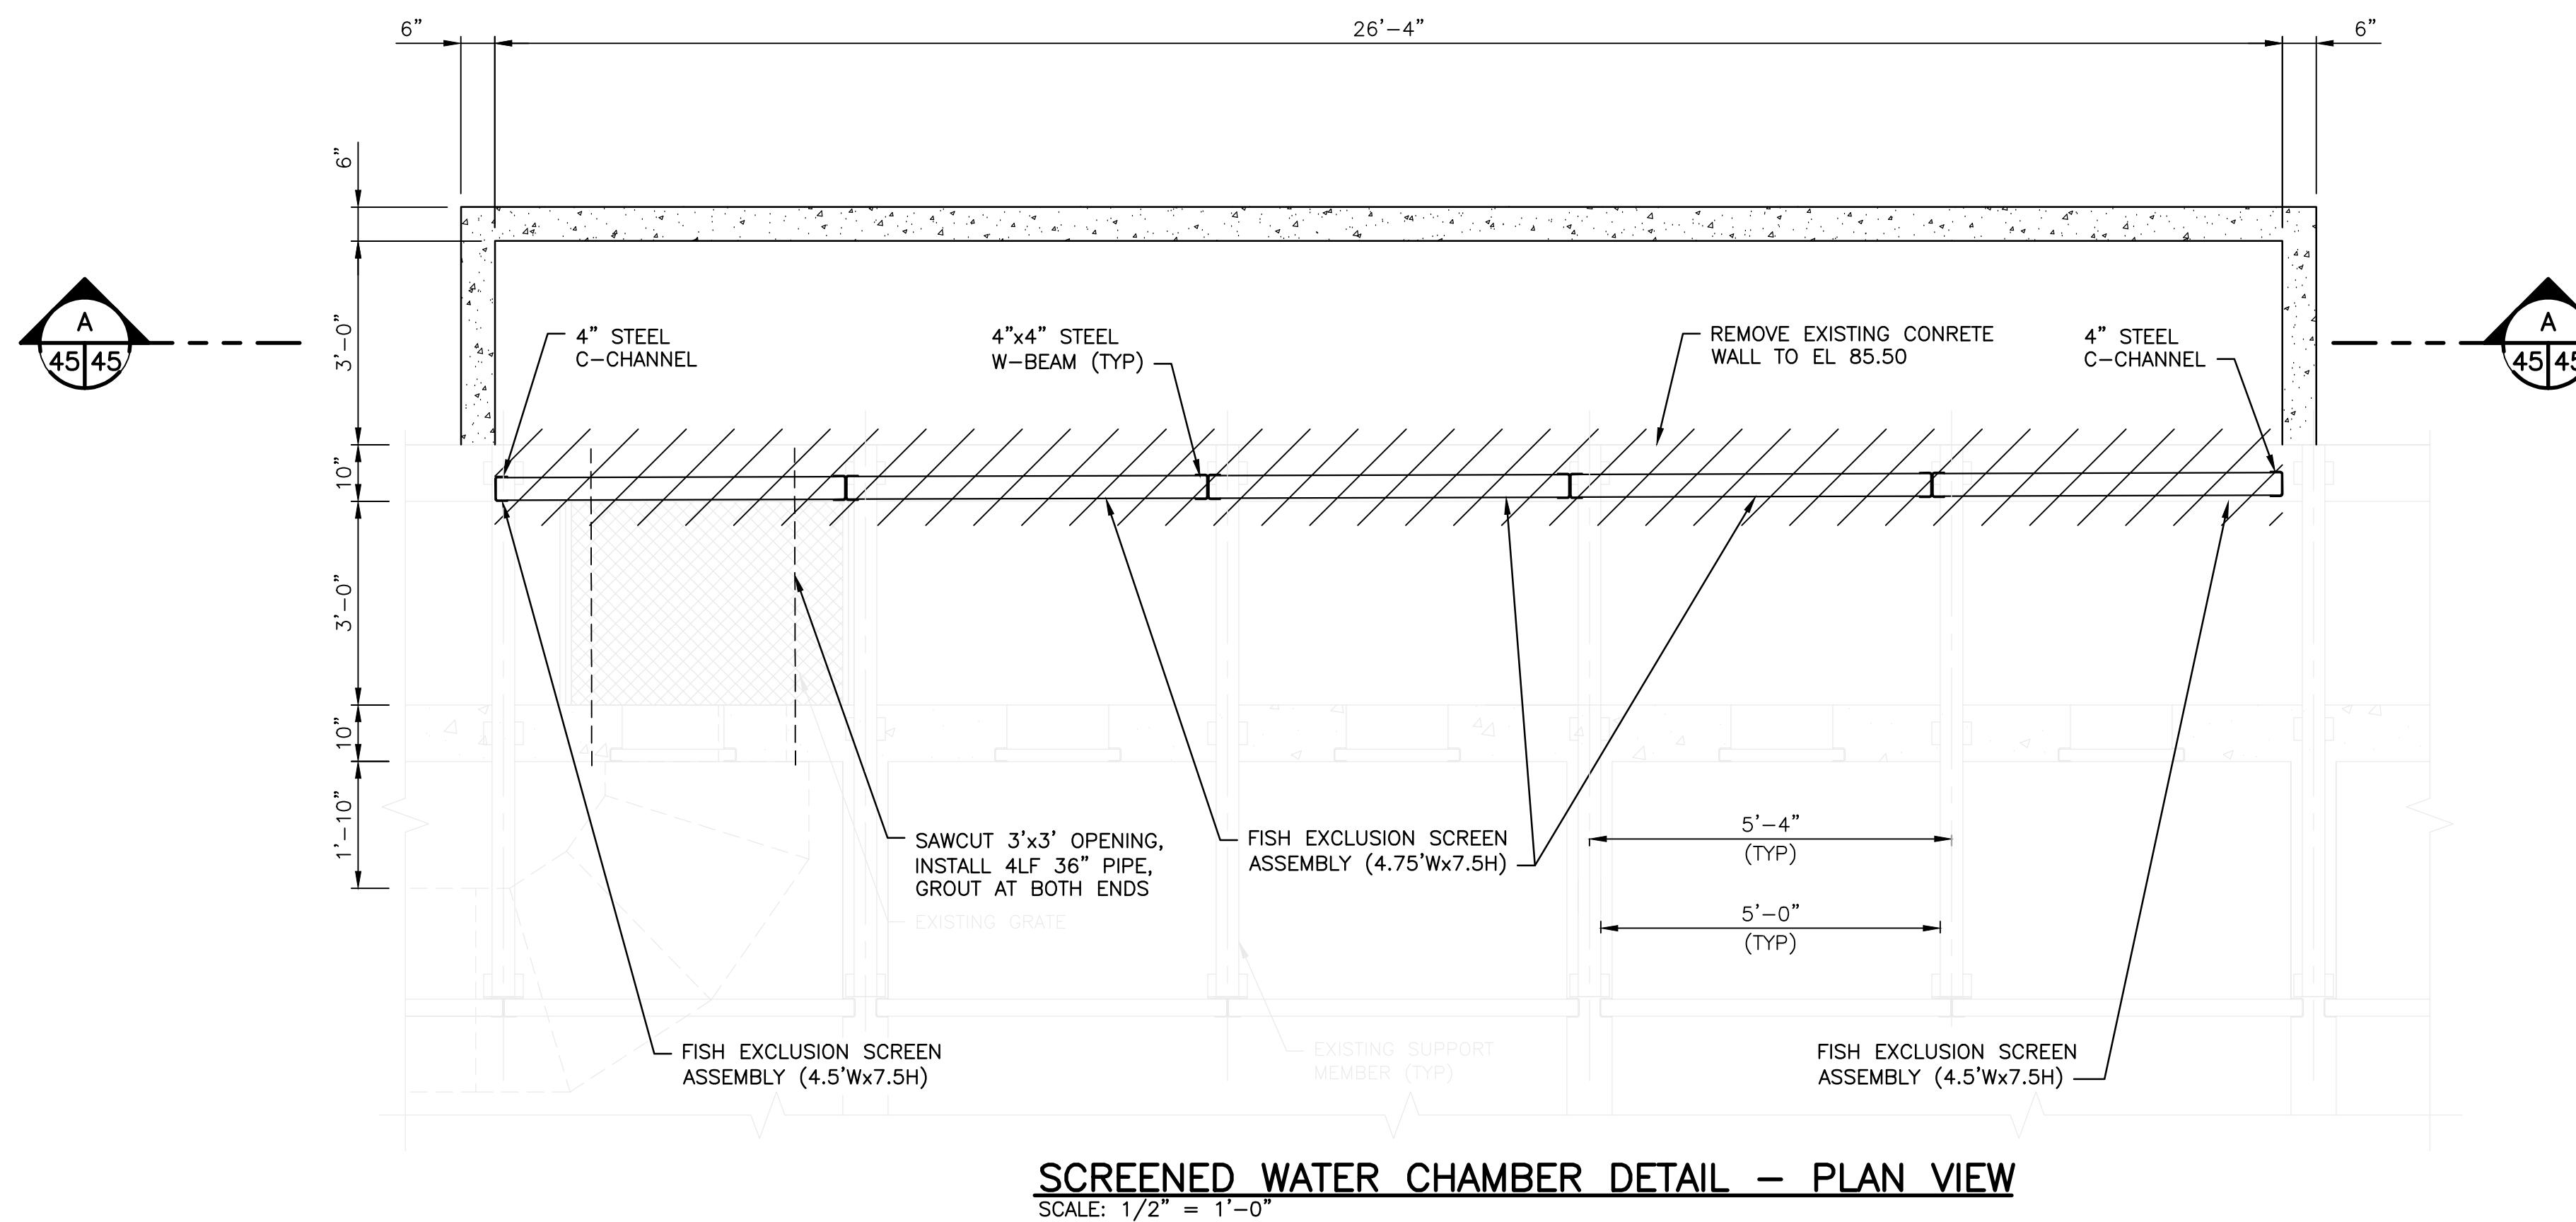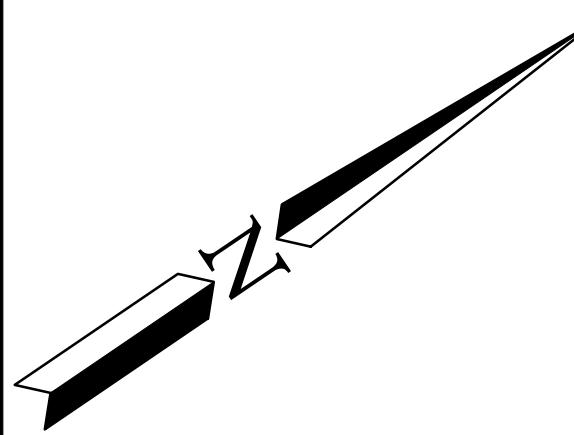SCALE: 1/2" = 1'-0"



**SECTI  
SCALE 1**

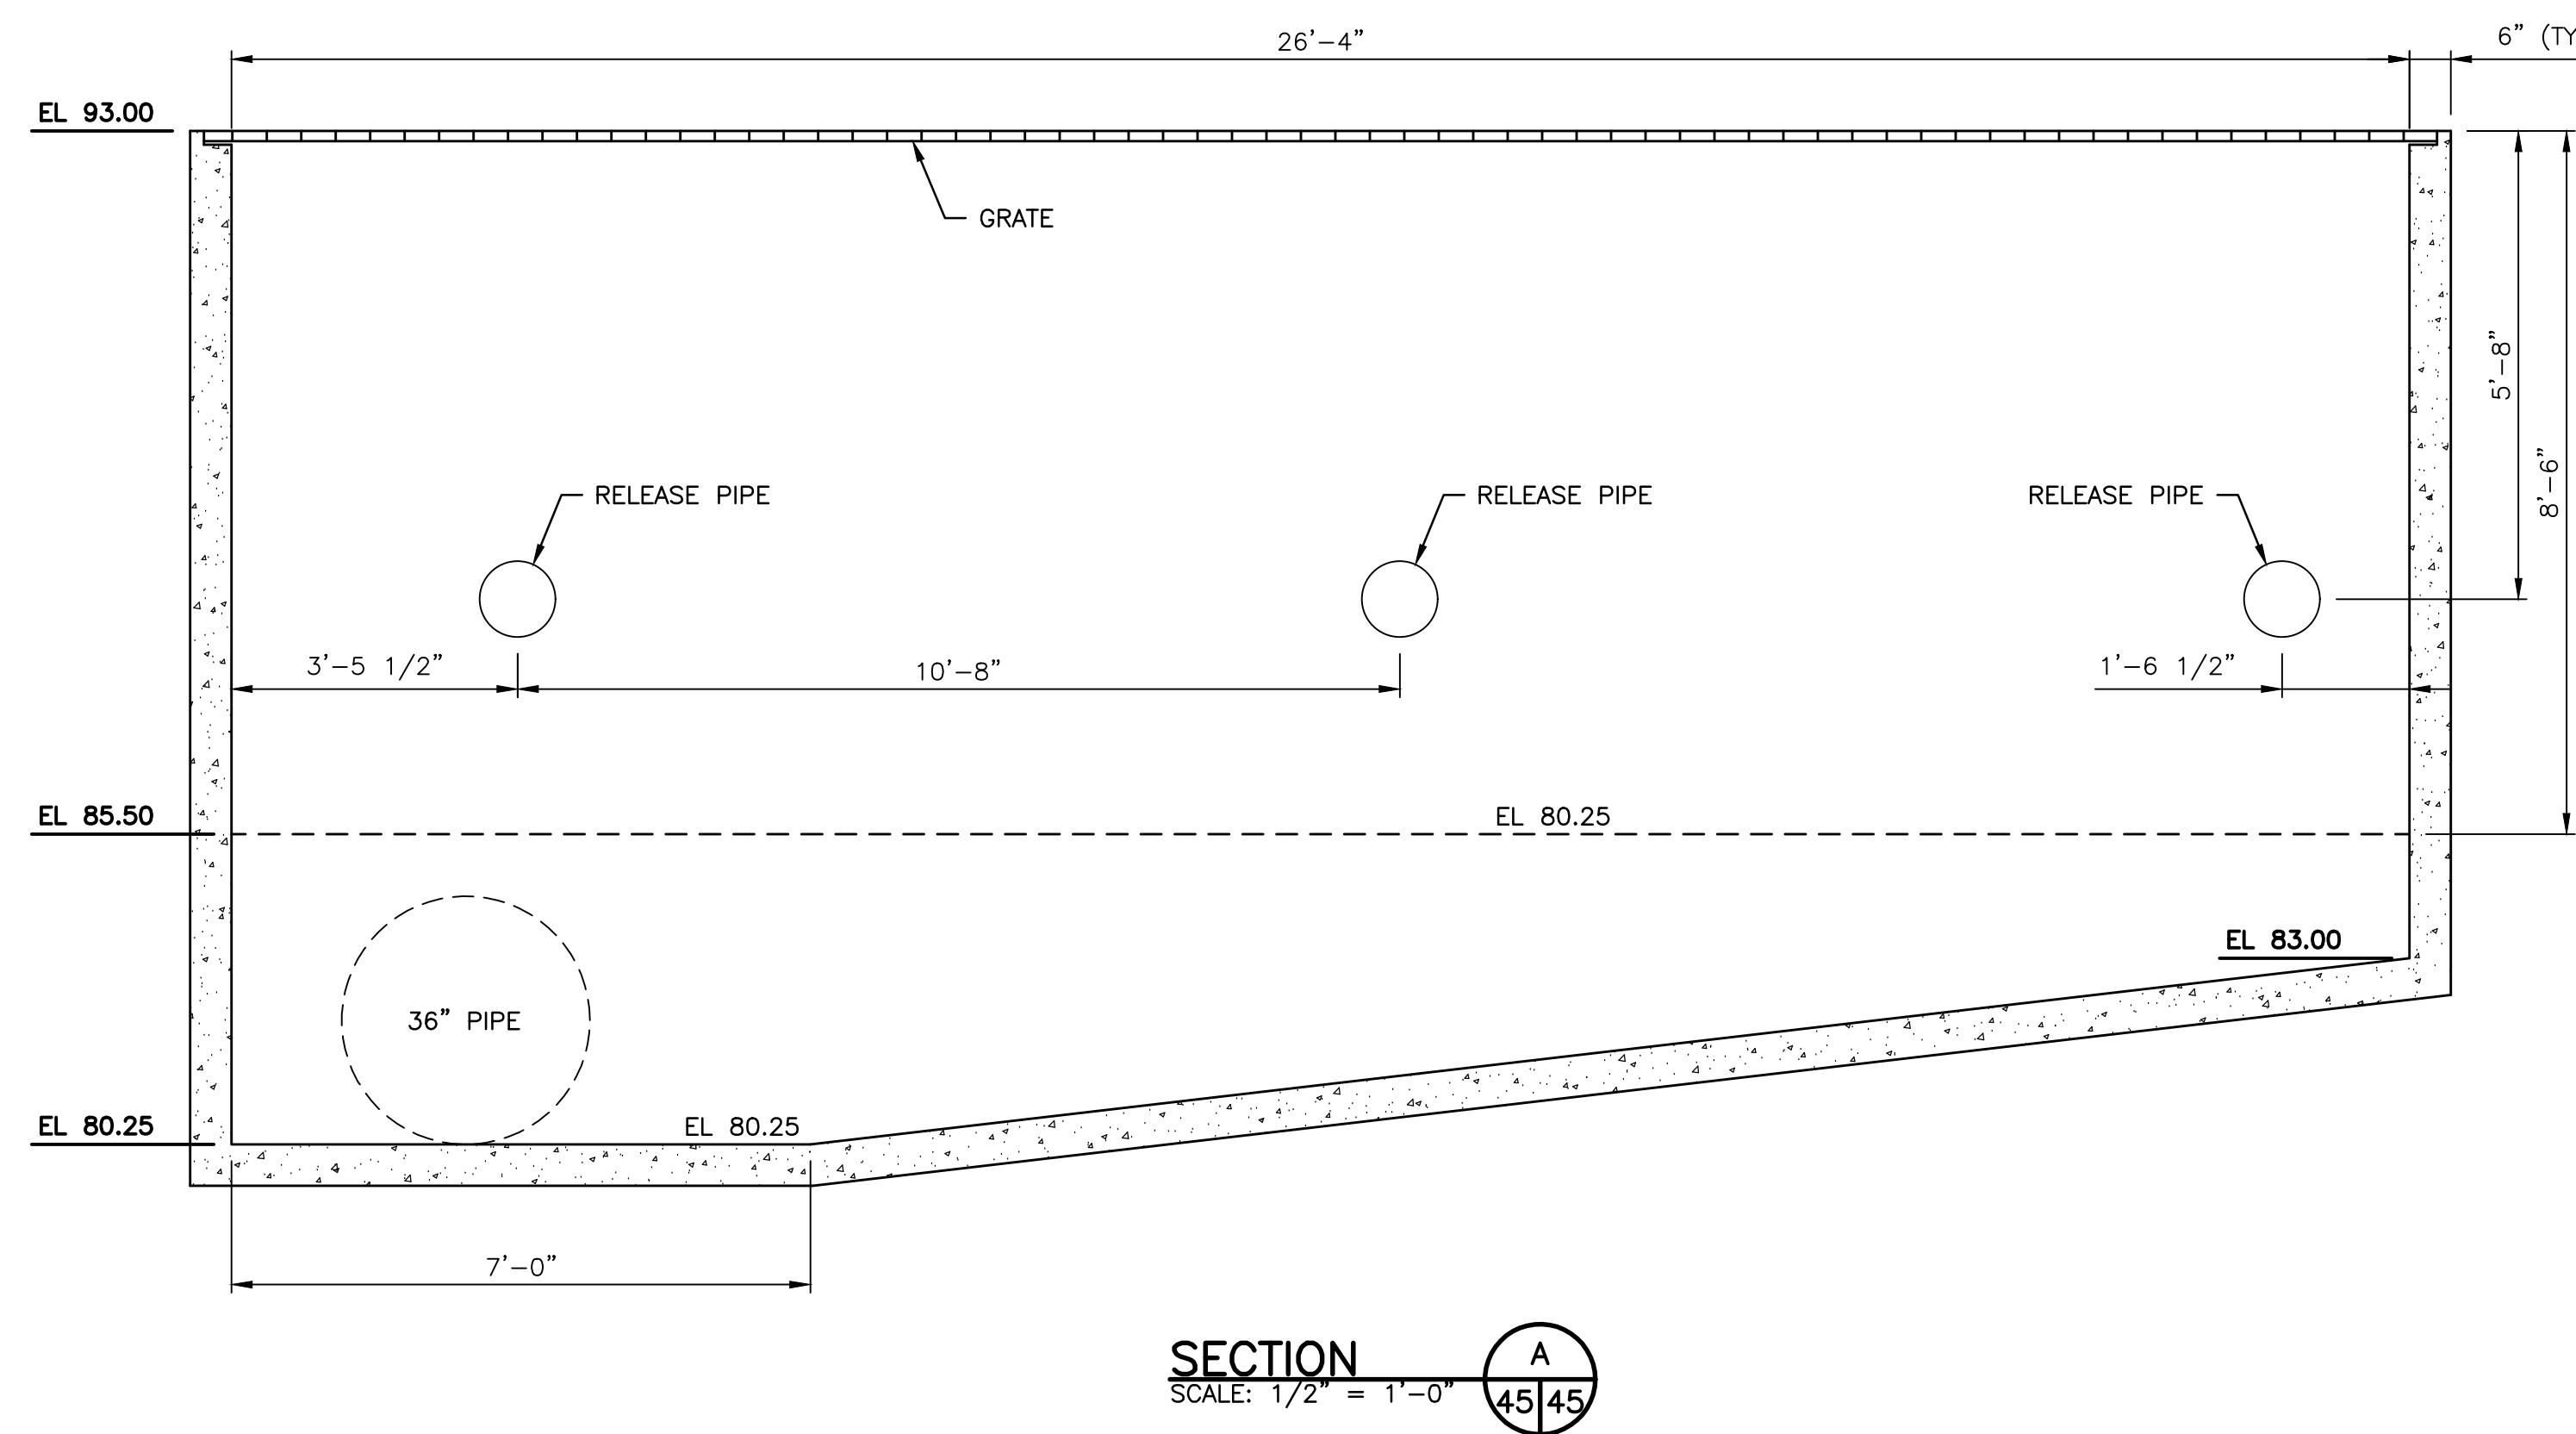SCALE: 1/



**Stantec**

*WASHINGTON DEPARTMENT OF  
FISH & WILDLIFE*

|  |      | <b>SCHEMATIC DESIGN</b><br><b>NOT FOR CONSTRUCTION</b><br><b>MAY 17, 2021</b> |    | 0 ————— 1"<br><b>BAR MEASURES<br/>ONE INCH ON<br/>22x34 DRAWINGS</b> |
|--|------|---|----|--|
| SYM                                    | DATE | REVISION DESCRIPTION  | BY | DESIGNED BY D. WHITBECK  |
| APPROVED AND RELEASED FOR CONSTRUCTION |      |   |    | CHECKED BY _____   |
| CHIEF ENGINEER .....                   |      |   |    | DATE: .....  |
| PROGRAM .....                          |      |   |    | DATE: .....  |
| DRAWN BY STANTEC                       |      |   |    |  |
| DATE 05/17/2021                        |      |   |    |  |

# SOOS CREEK HATCHERY

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## WATER SUPPLY TREATMENT REUSE SCREEN CHAMBER PLAN AND SECTION


**DISCIPLINE SHEET #**  
**S15.2**

PROJECT NO.

XX:X##:####-#


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OF

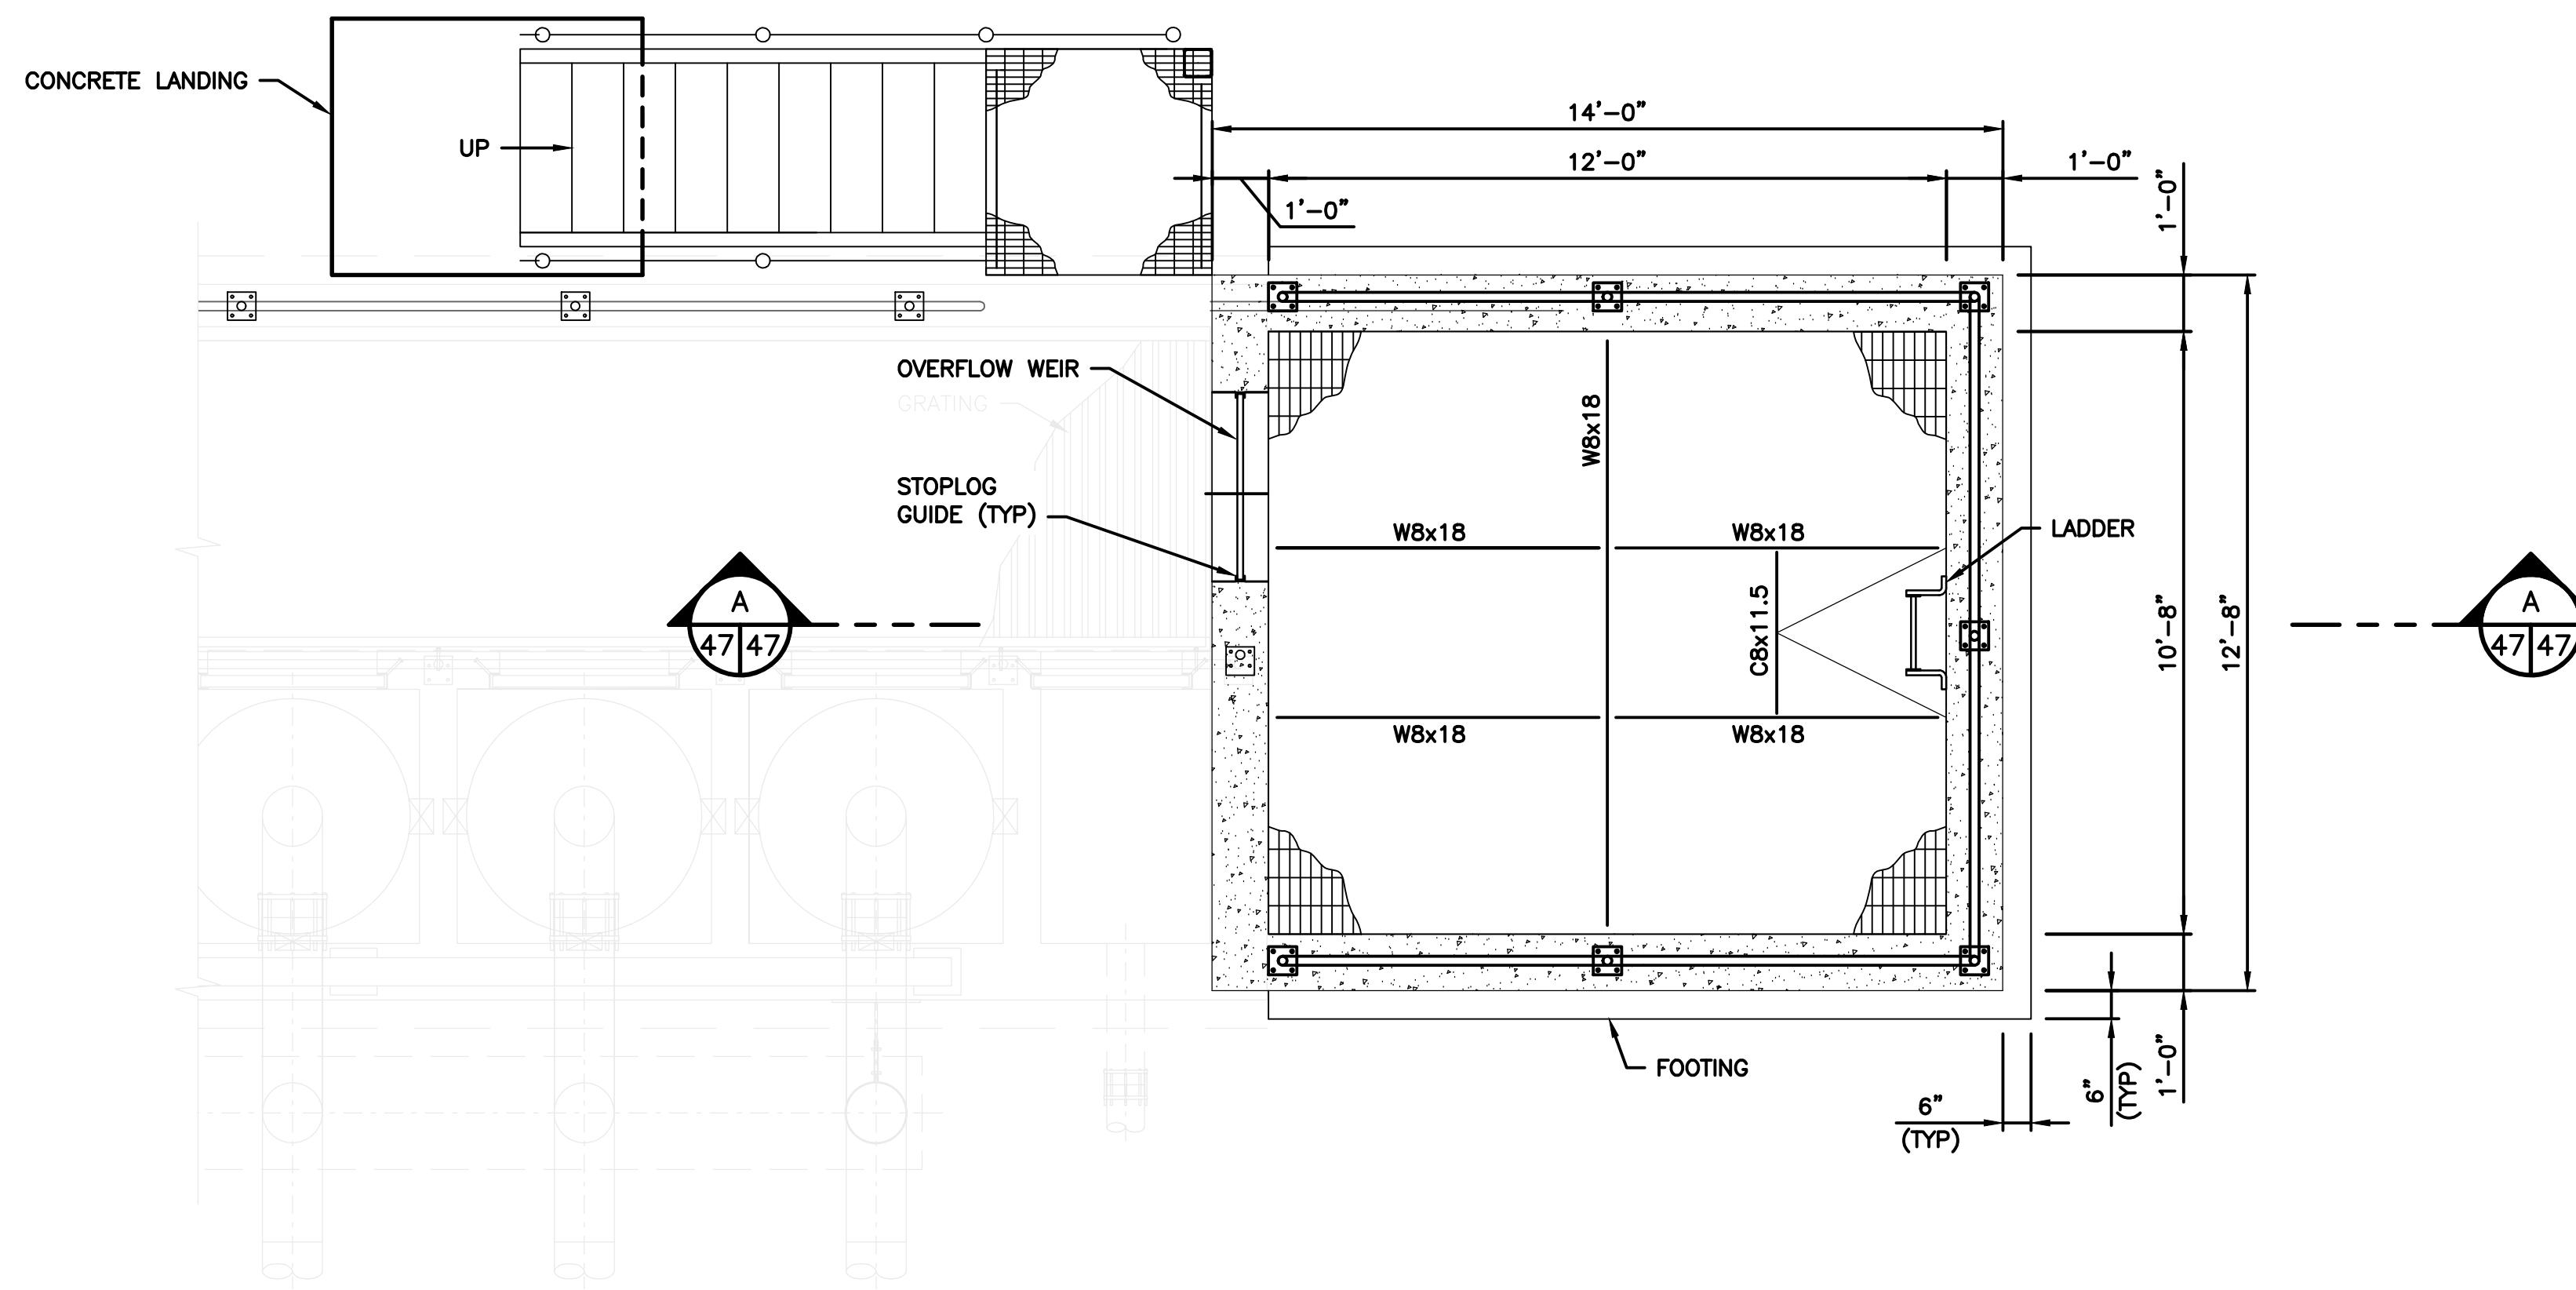


DISTRIBUTION BOX 2 PLAN

SCALE: 3/8" = 1'-0"

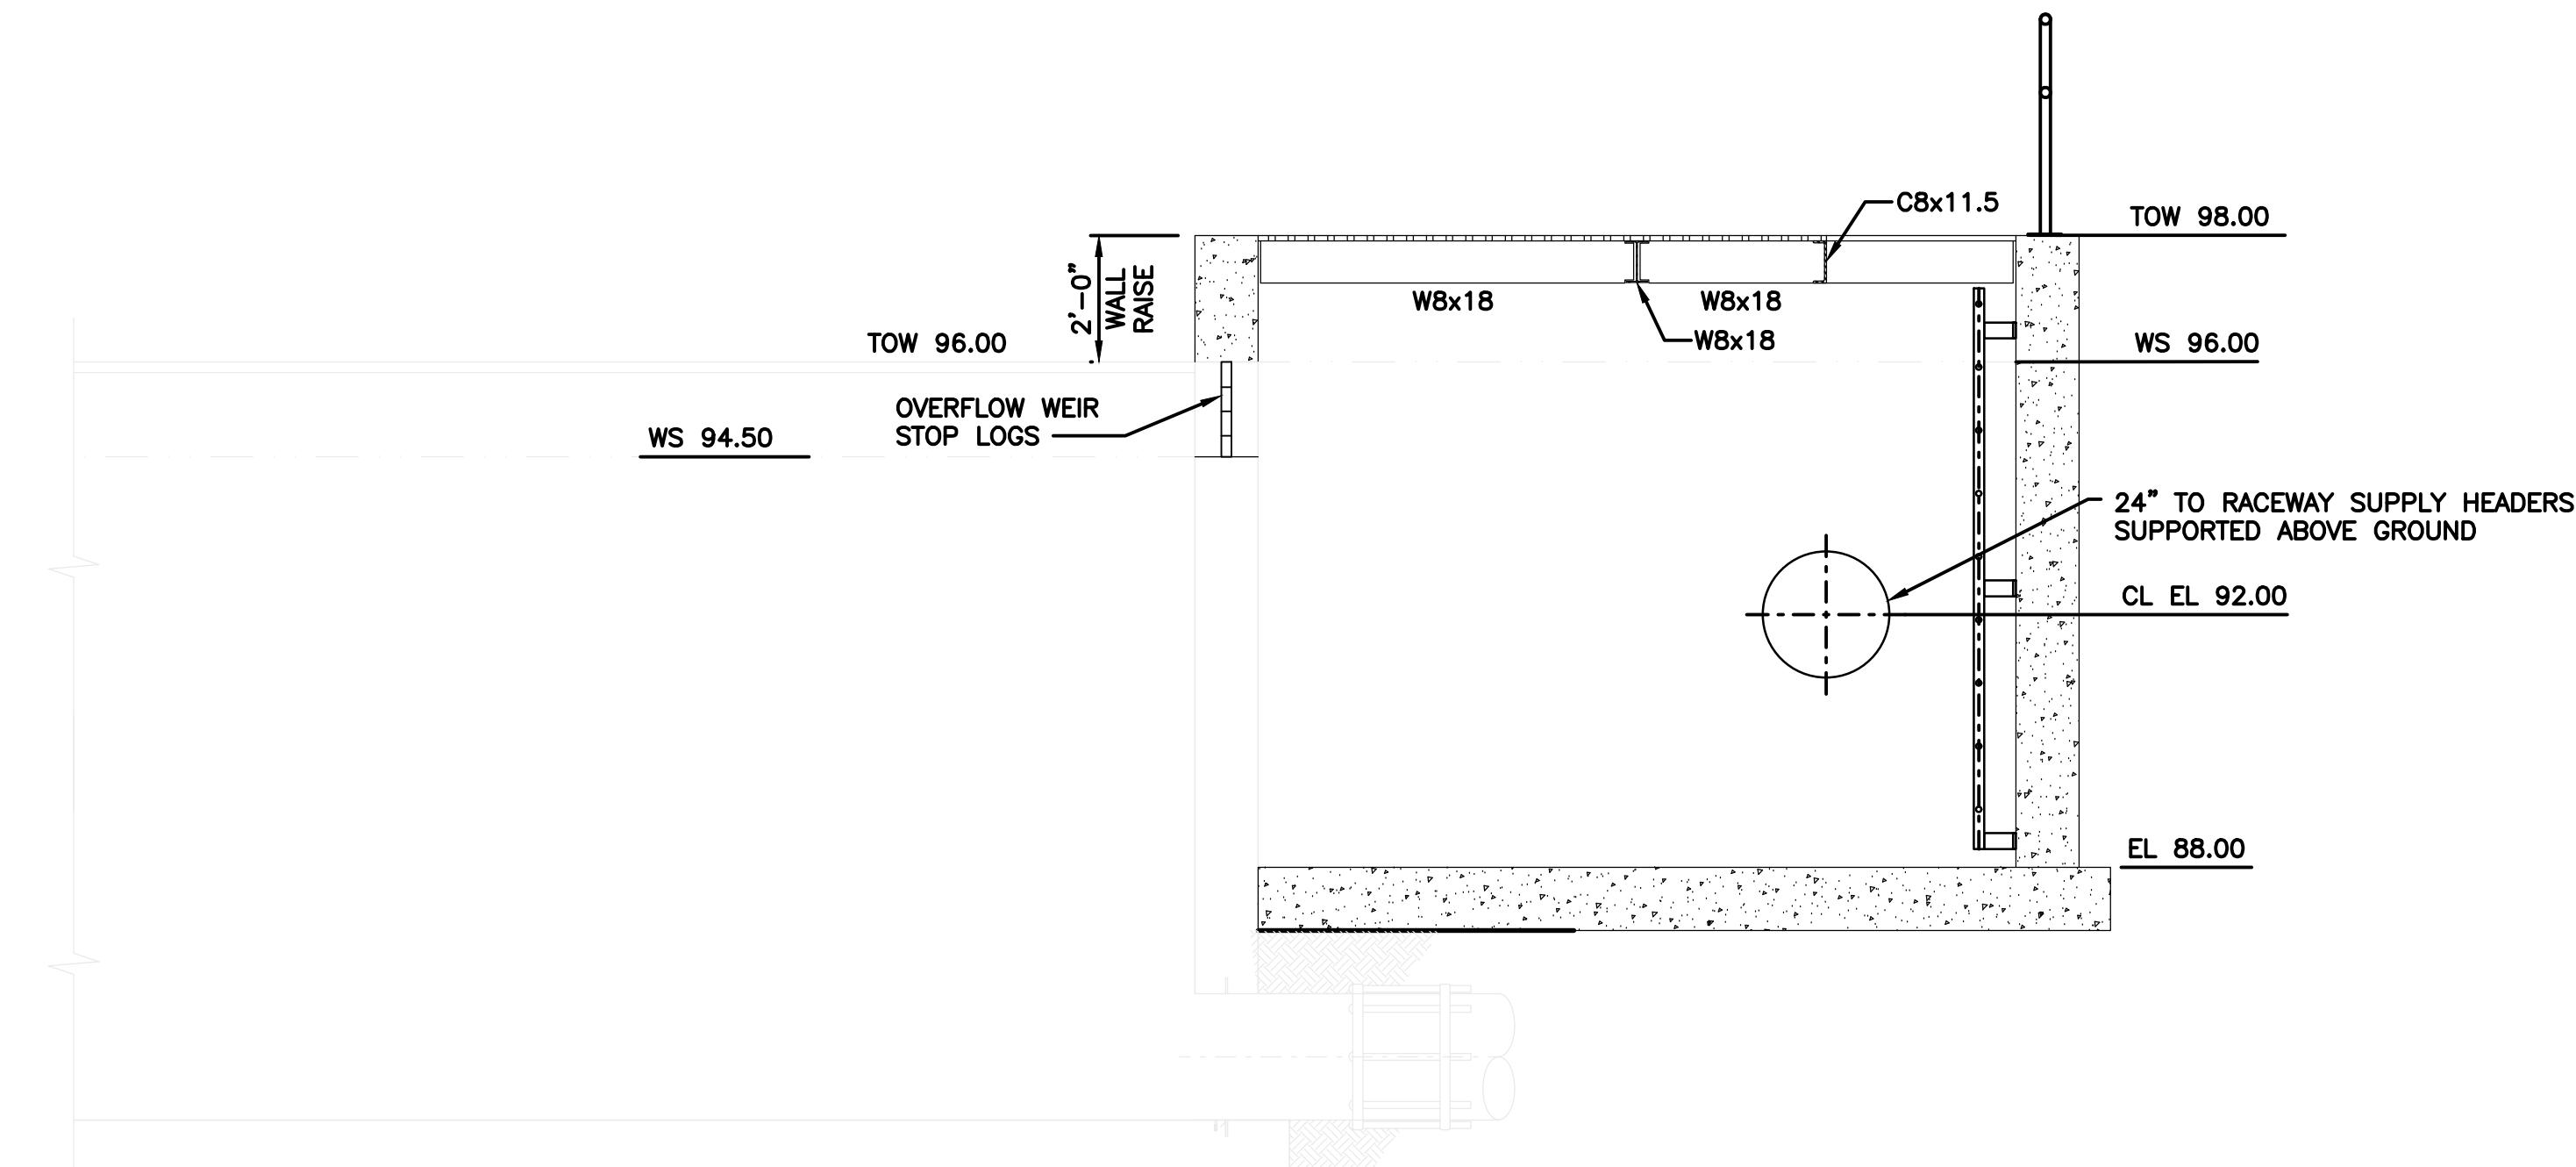

SECTION  
SCALE: 3/8" = 1'-0" A 47 47

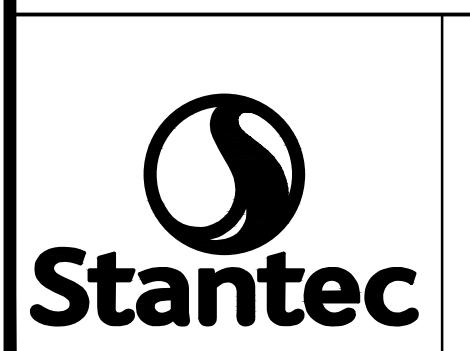

WASHINGTON DEPARTMENT OF  
FISH & WILDLIFE

SCHEMATIC DESIGN  
NOT FOR CONSTRUCTION  
MAY 17, 2021

APPROVED AND RELEASED FOR CONSTRUCTION

CHIEF ENGINEER ..... DATE: ..... DATE: .....  
PROGRAM ..... DATE: ..... DATE: .....

0 \_\_\_\_\_ 1"  
BAR MEASURES  
ONE INCH ON  
22x34 DRAWINGS

DESIGNED BY F. LAST

CHECKED BY F. LAST

DRAWN BY S. NADKAR



DATE MM/DD/YYYY

SOOS CREEK HATCHERY  
WATER SUPPLY TREATMENT  
DISTRIBUTION BOX 2  
EXPANSION PLAN

DISCIPLINE SHEET #  
**S16.1**

PROJECT NO.  
XX:X##:###-#

SHEET 47 OF 73

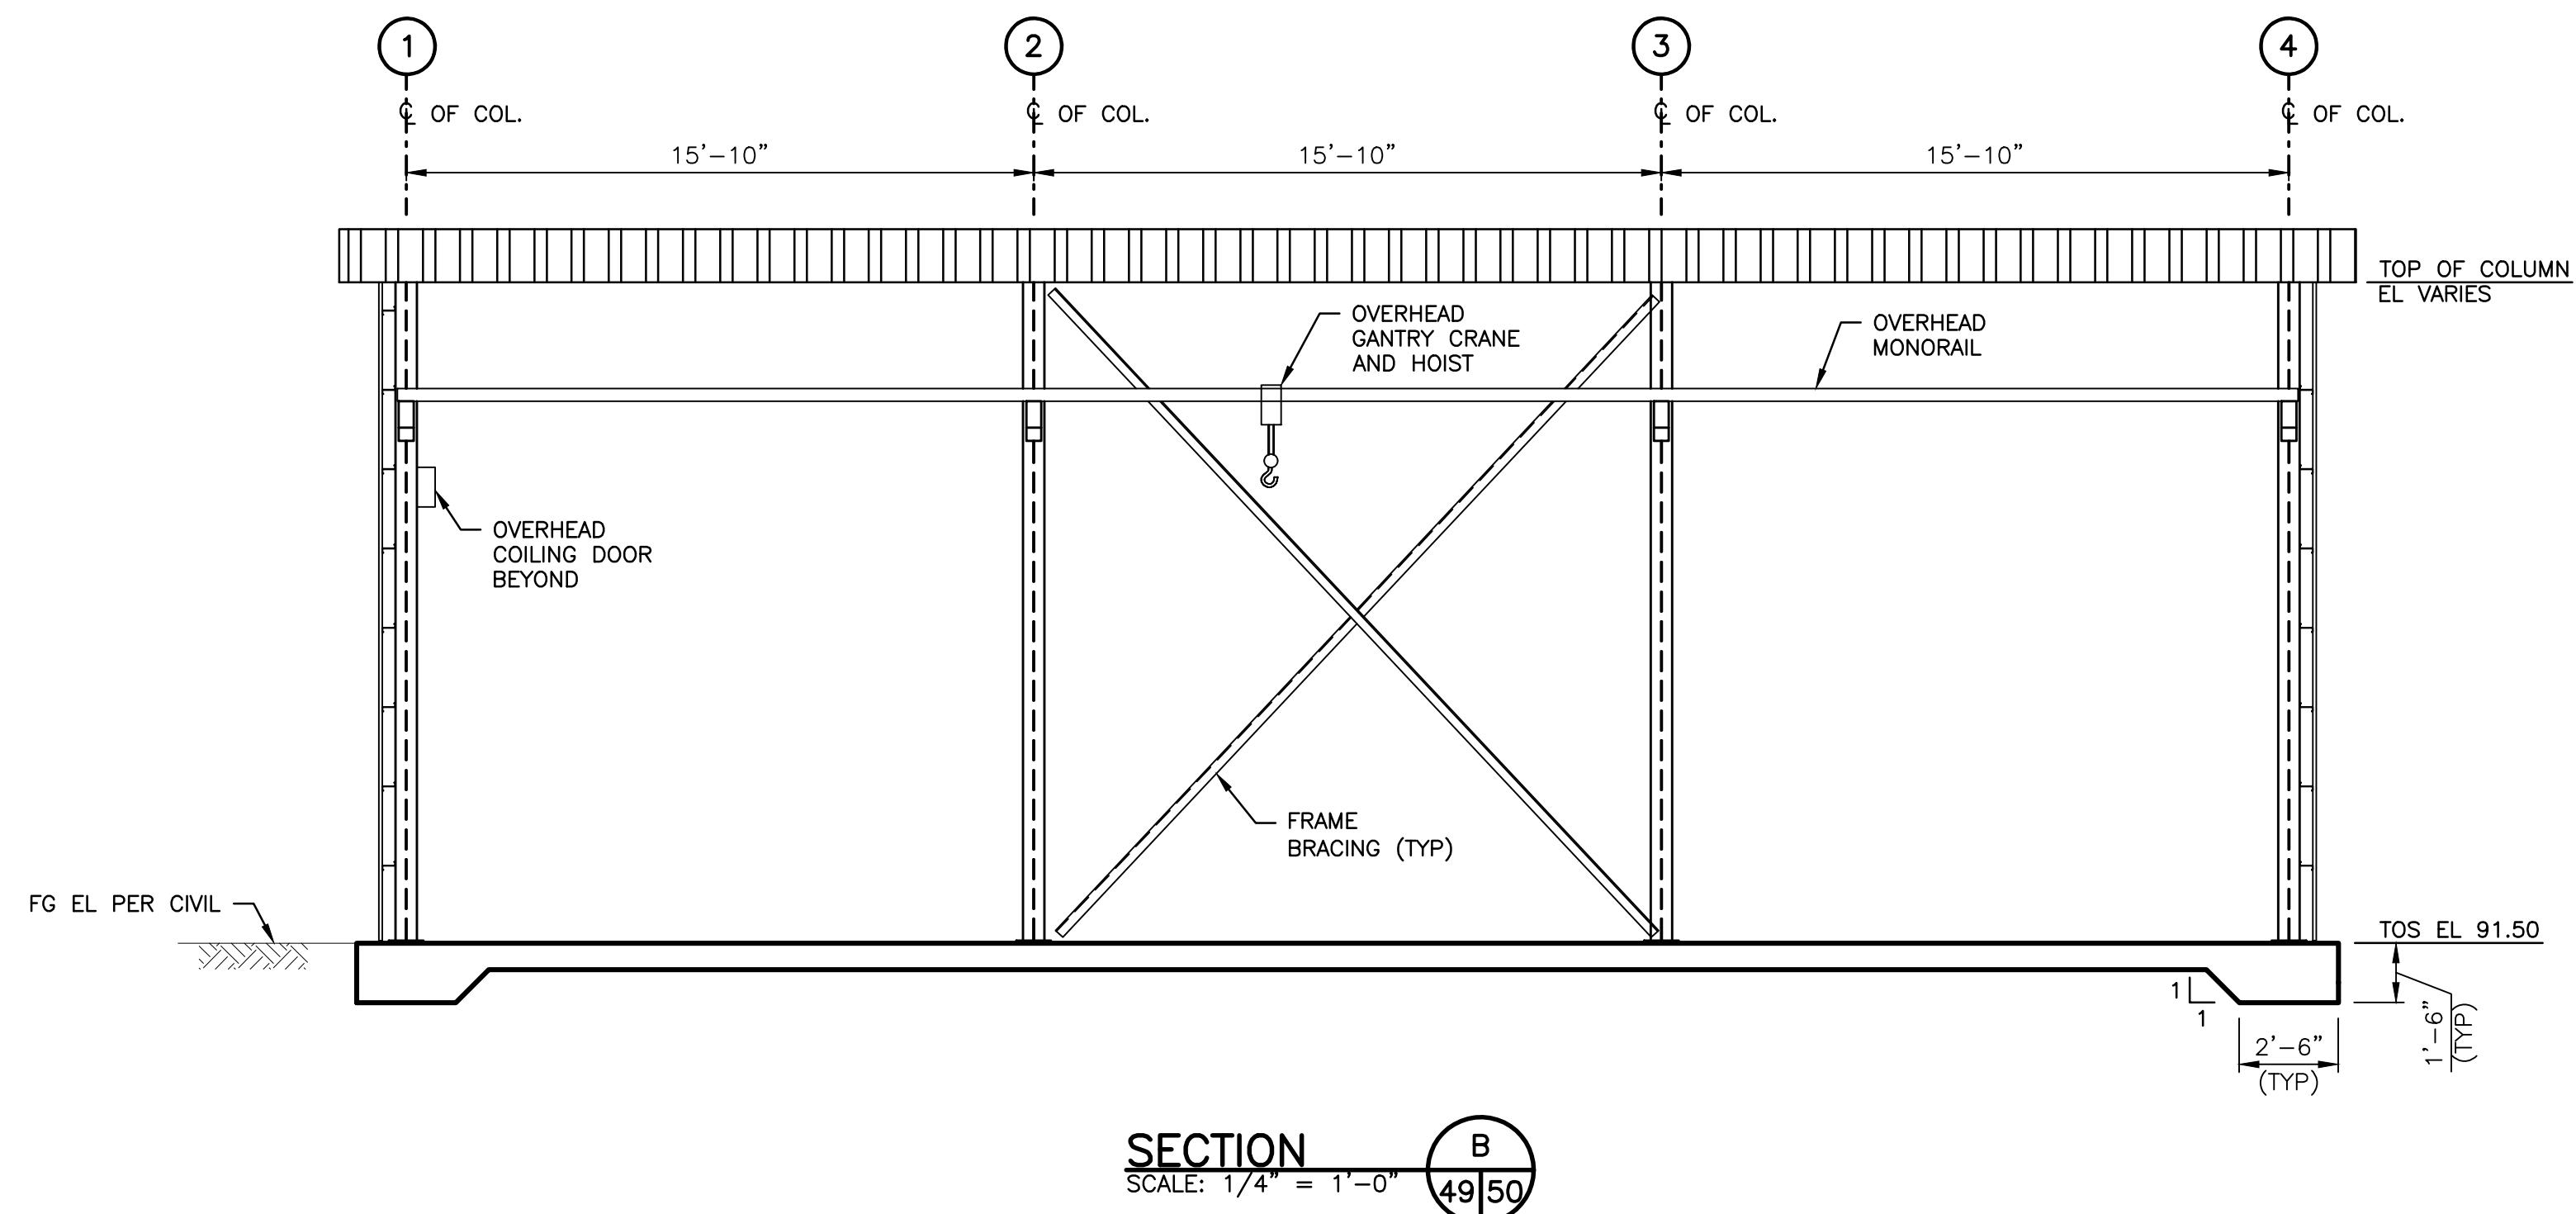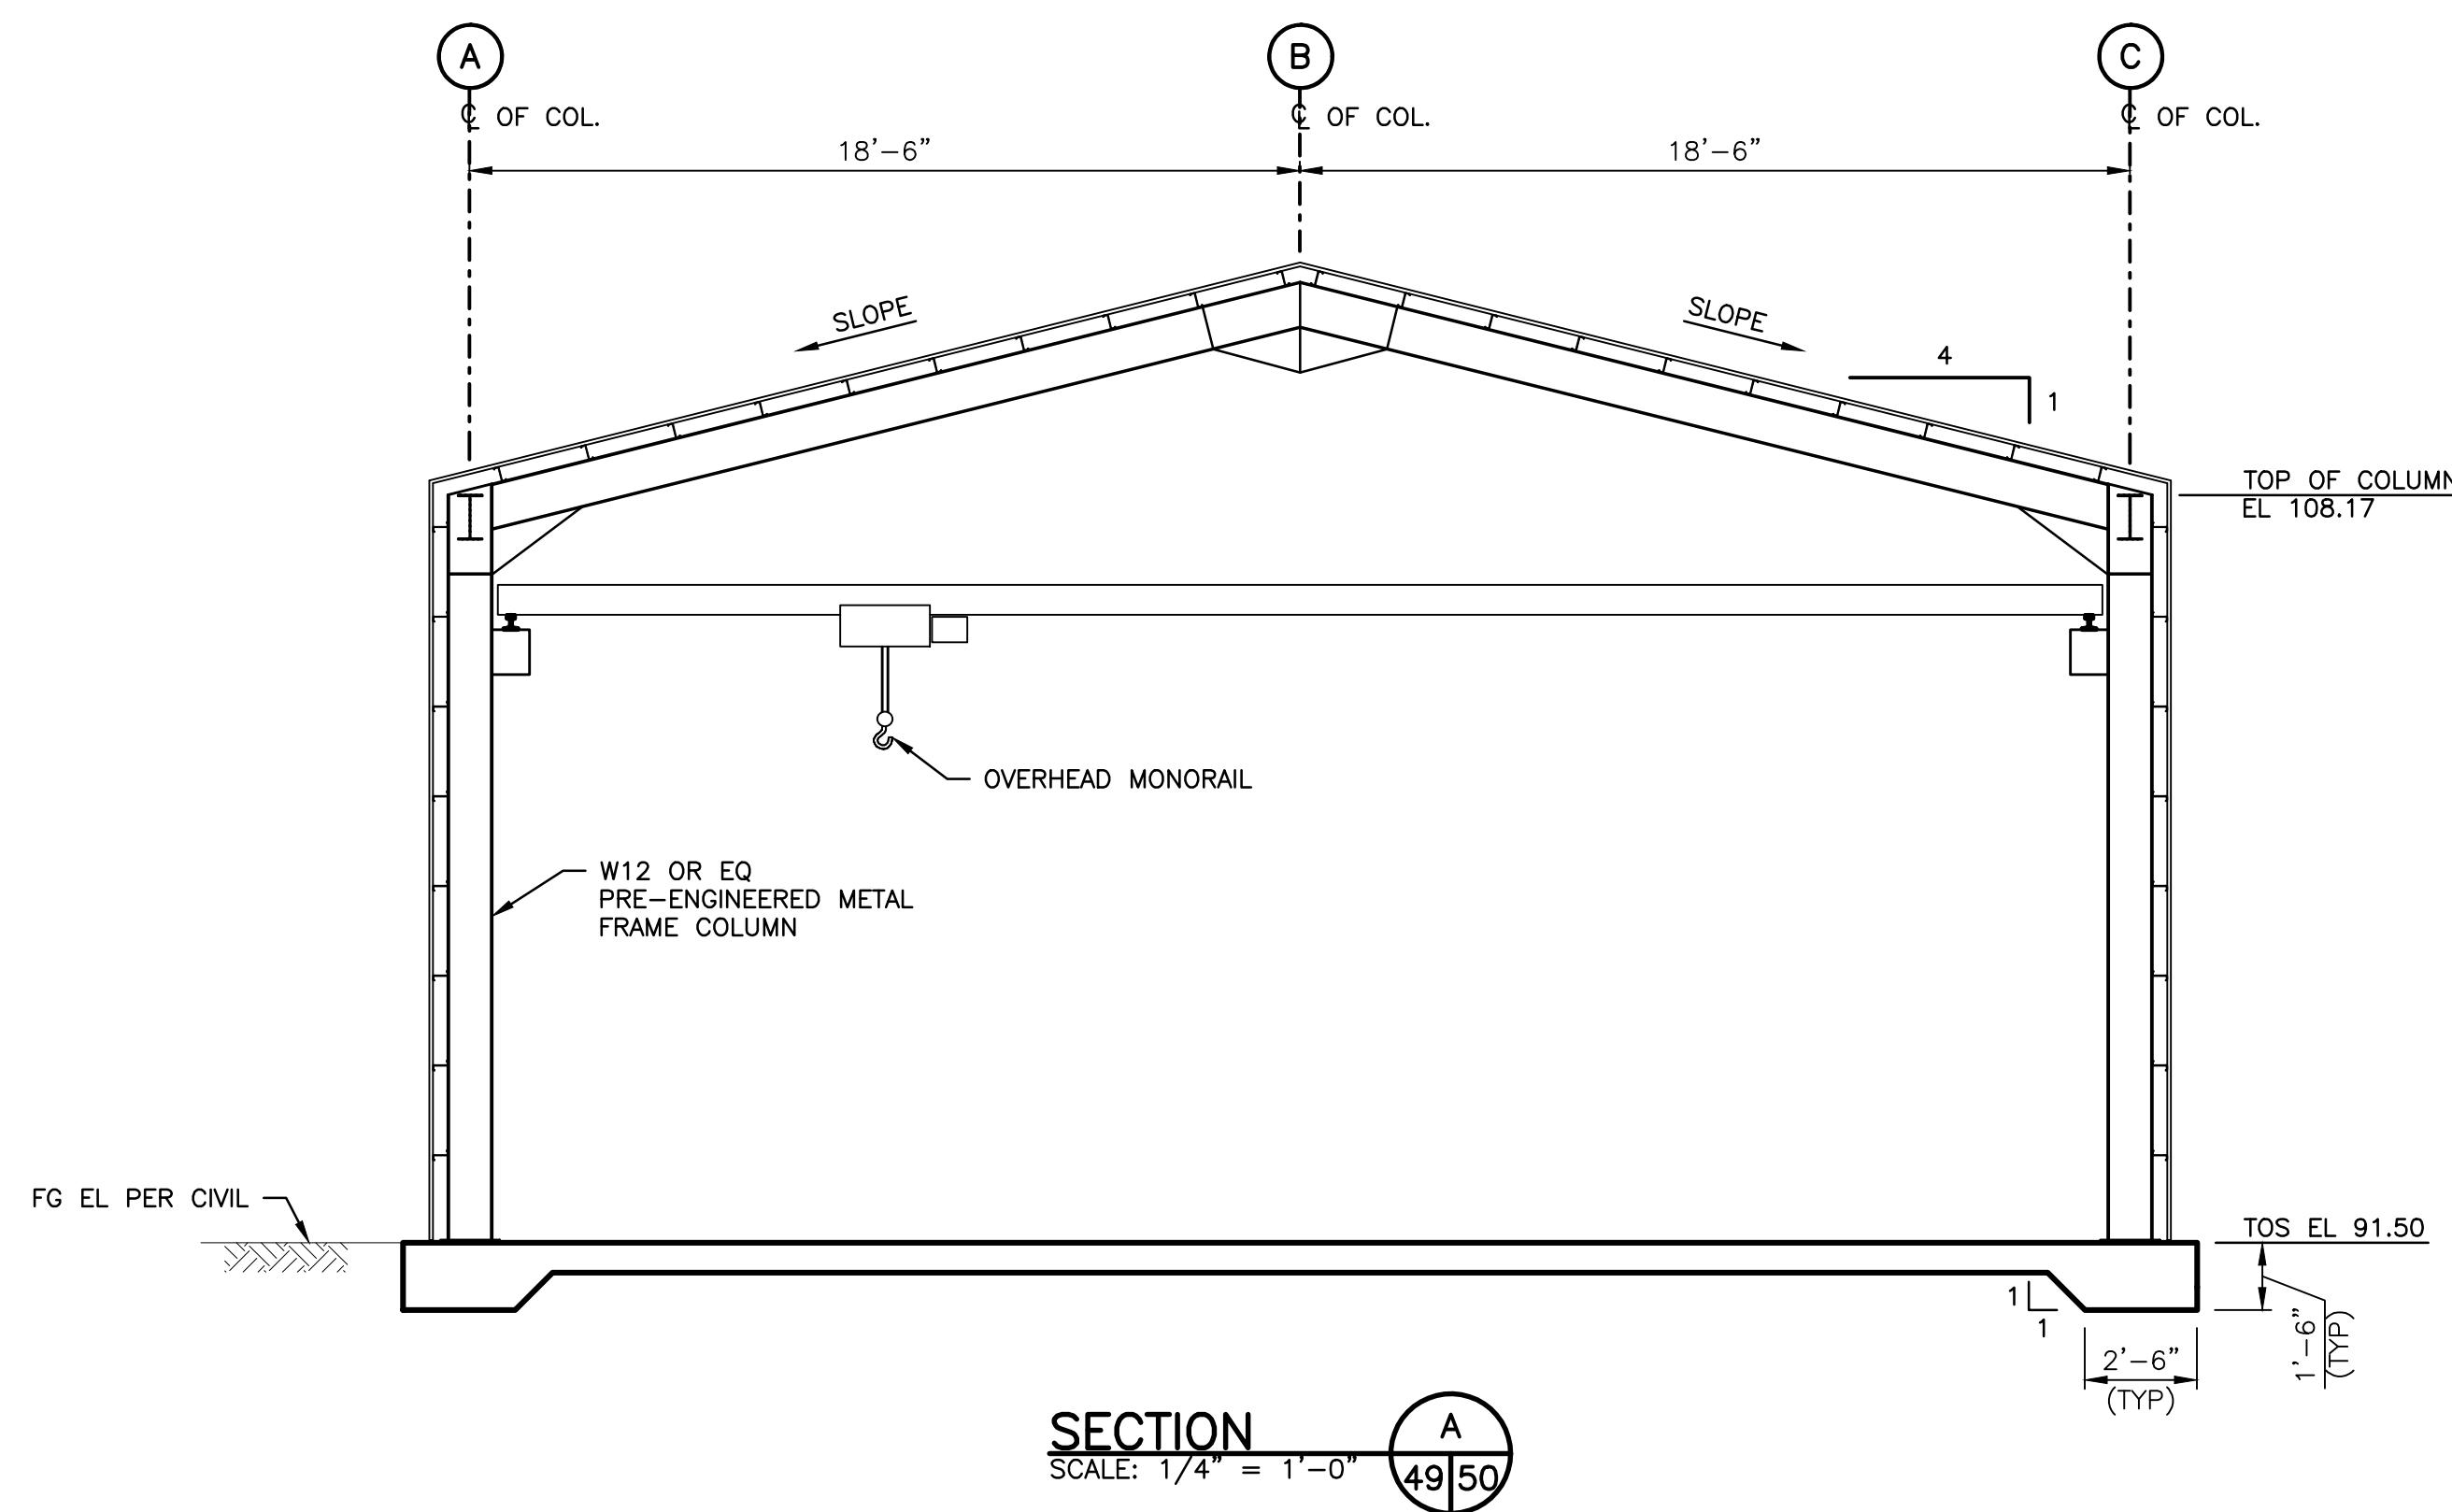

**WASHINGTON DEPARTMENT OF  
FISH & WILDLIFE**

SCHEMATIC DESIGN  
NOT FOR CONSTRUCTION  
MAY 17, 2021

APPROVED AND RELEASED FOR CONSTRUCTION

CHIEF ENGINEER ..... DATE: ..... DATE: .....  
PROGRAM ..... DATE: ..... DATE: .....

0 ————— 1" BAR MEASURES  
ONE INCH ON  
22x34 DRAWINGS

DESIGNED BY D. WHITBECK

CHECKED BY \_\_\_\_\_

DRAWN BY STANTEC

DATE 05/17/2021

**SOOS CREEK HATCHERY  
WATER SUPPLY TREATMENT  
FILTER BUILDING  
SECTIONS AND DETAILS**

DISCIPLINE SHEET #  
**S23.2**

PROJECT NO.


XX:X##:###-#

SHEET

50


OF

74

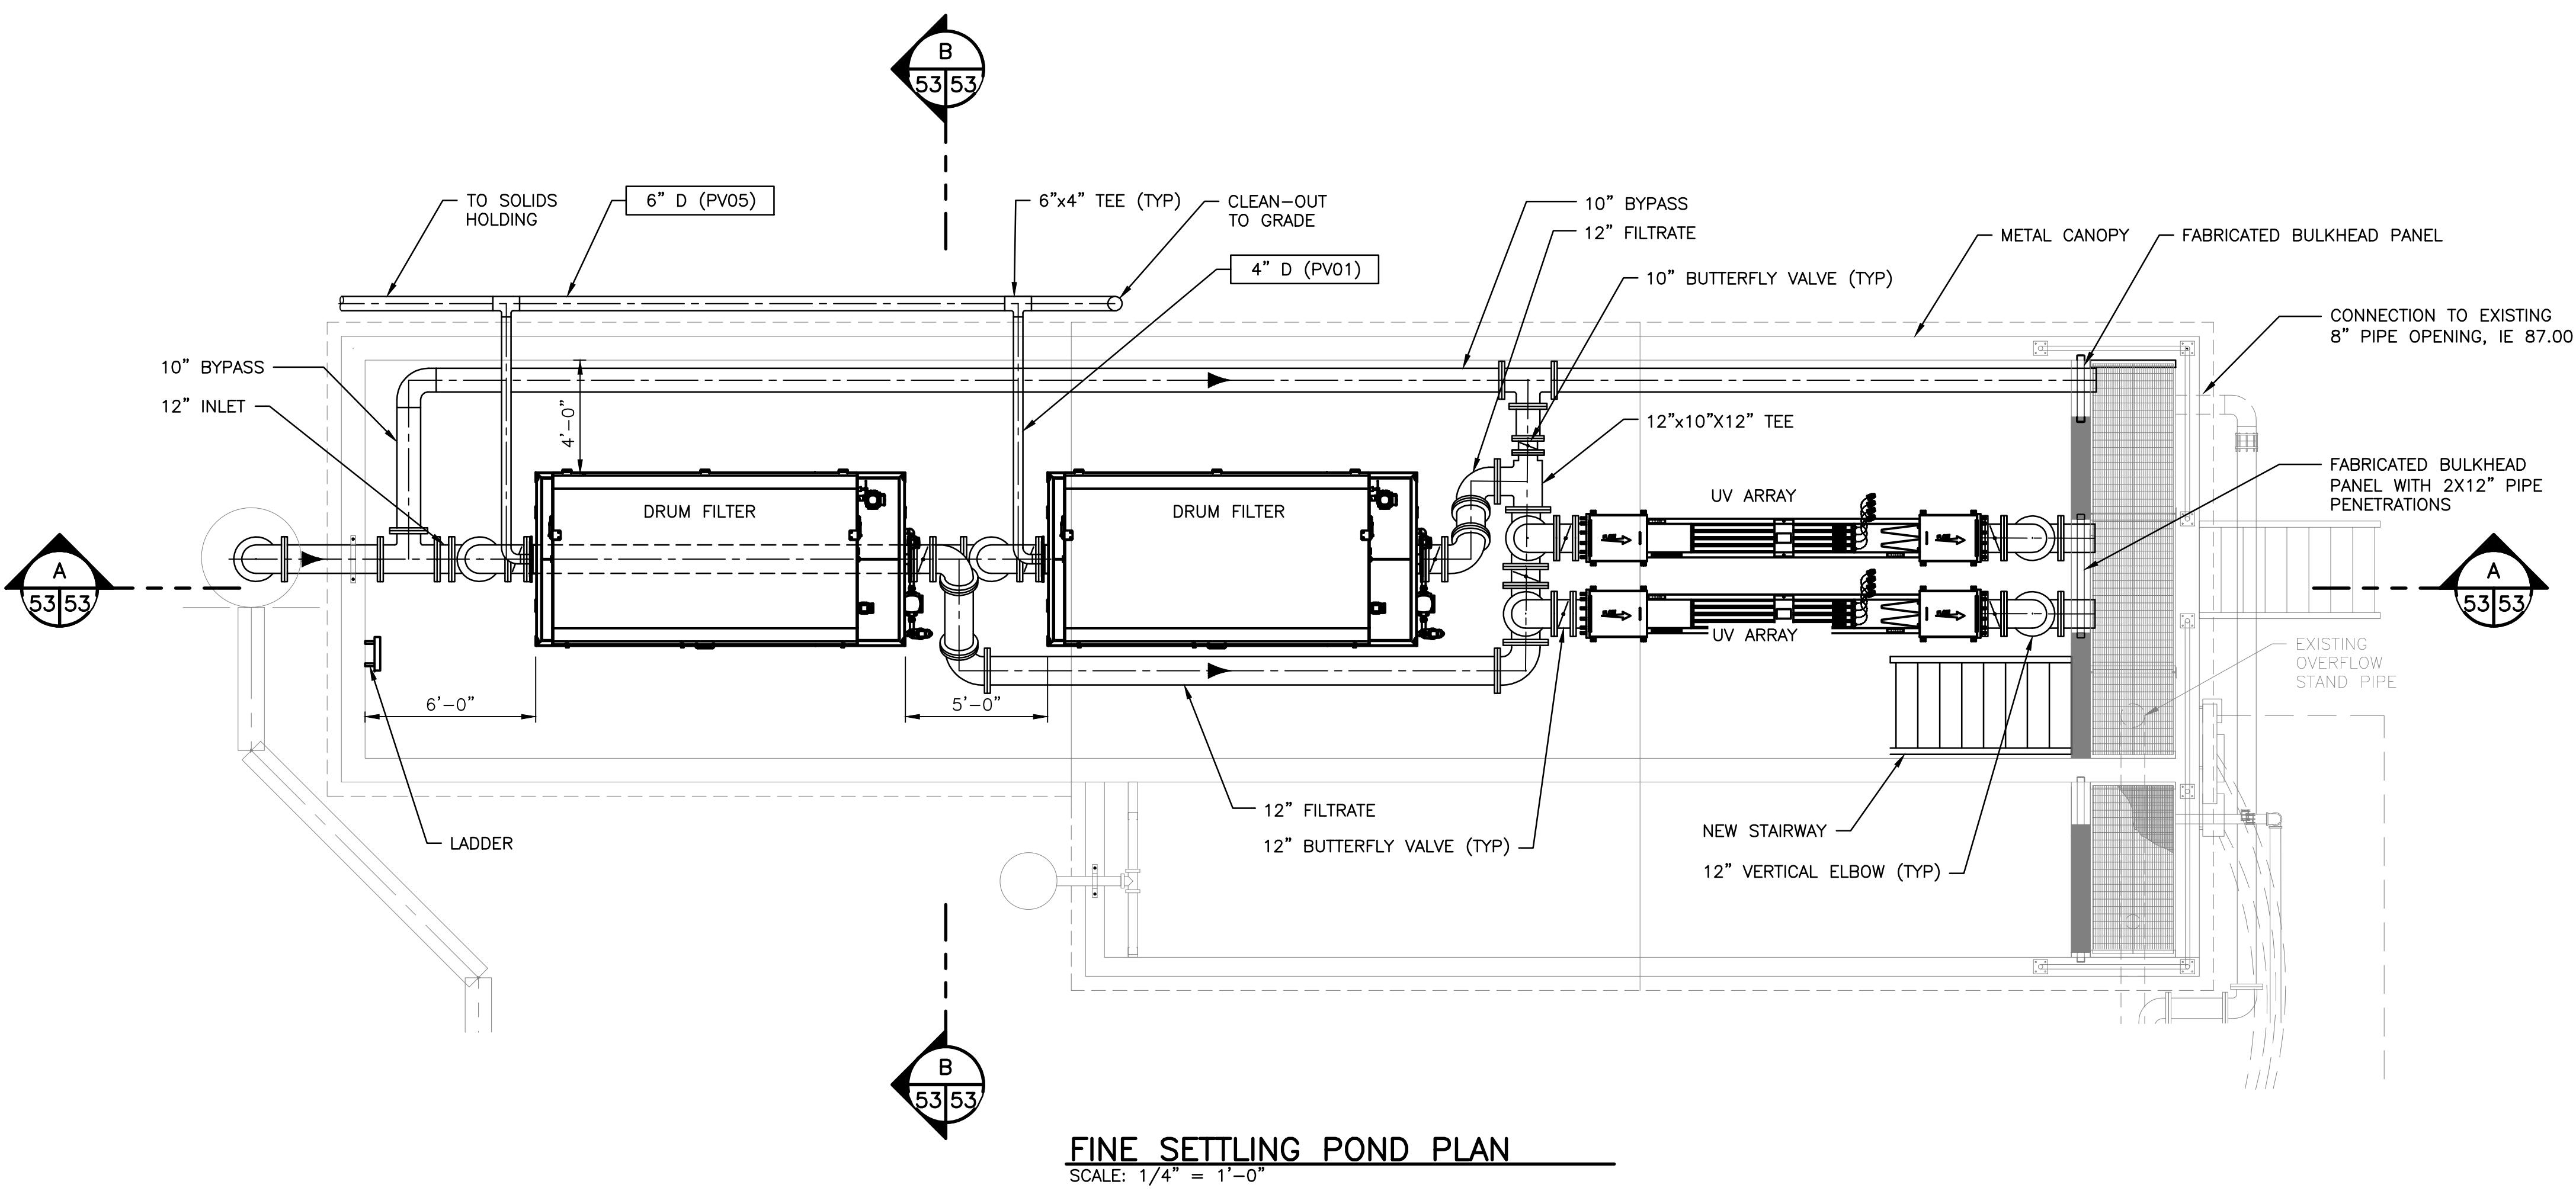

# FINE SETTLING POND PLAN

**SCALE: 1/4" = 1'-0"**

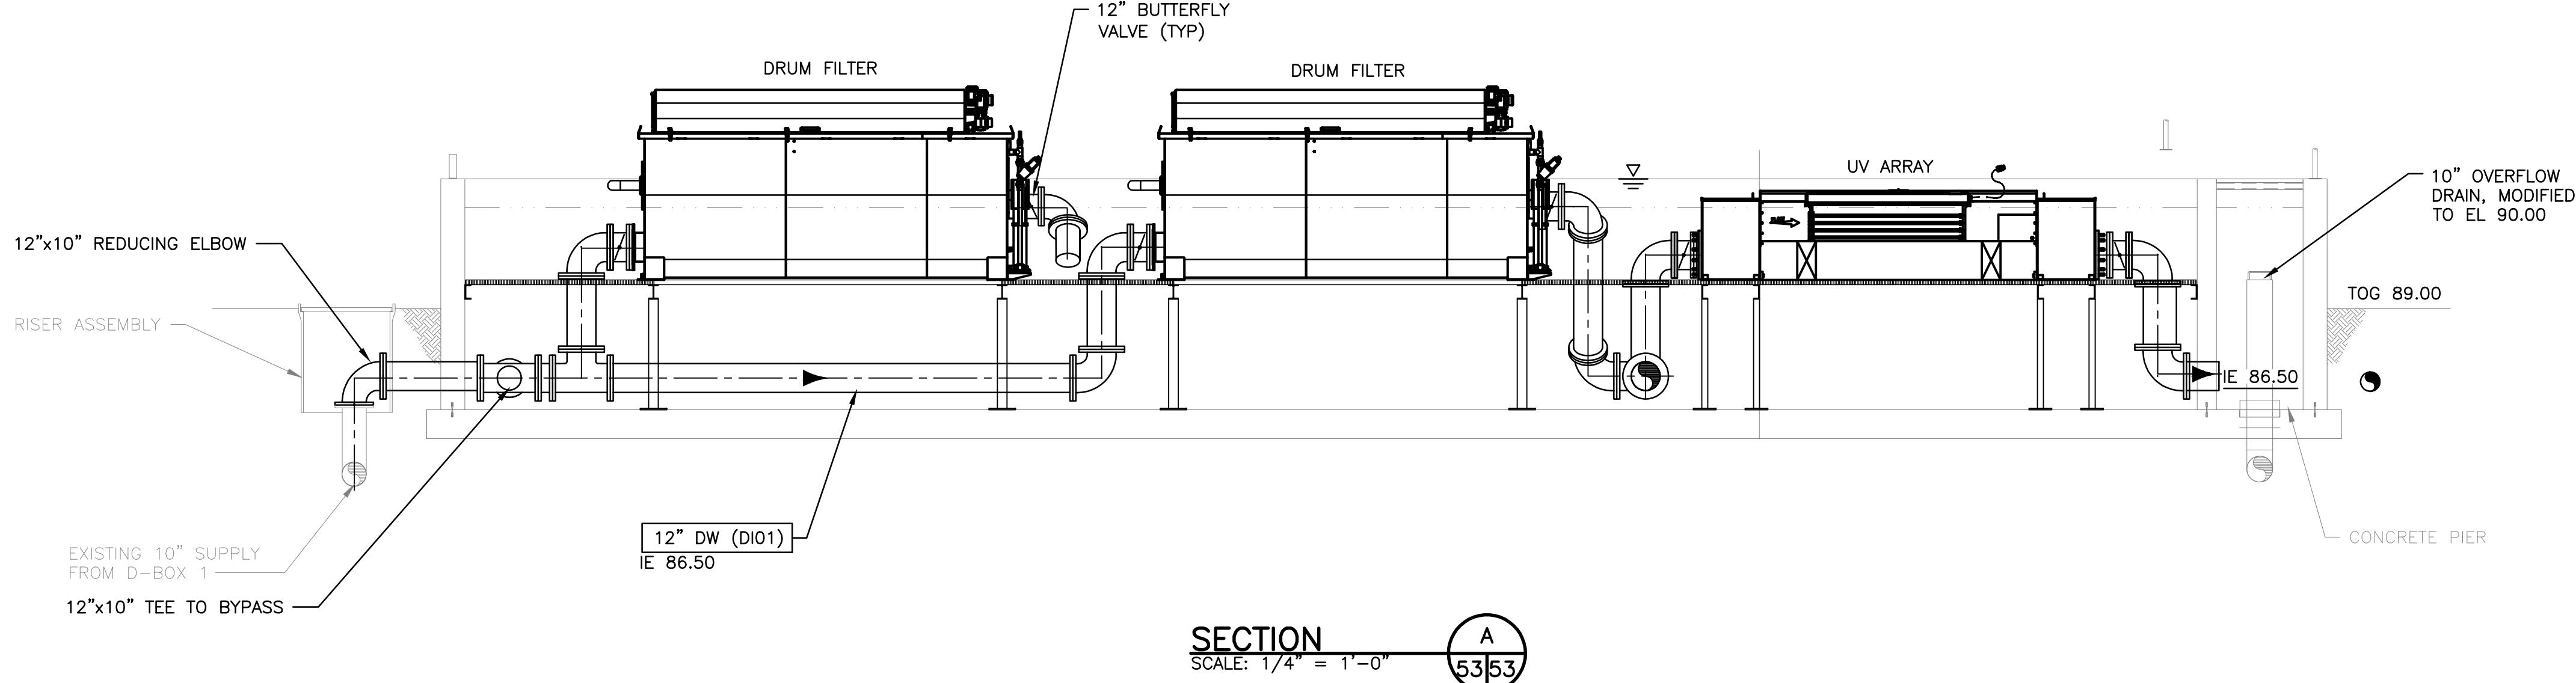

## SECTION

SCALE: 1/4" = 1'-0"



*WASHINGTON DEPARTMENT OF  
FISH & WILDLIFE*

|  |             |                  |   |
|--|-------------|------------------|---|
| SCHEMATIC DESIGN<br>NOT FOR CONSTRUCTION<br>MAY 17, 2021 |             |                  | 0 _____ 1"<br>BAR MEASURES<br>ONE INCH ON<br>22x34 DRAWINGS |
| REVISION   | DESCRIPTION | BY               | DESIGNED BY D. WHITBECK                                     |
| APPROVED AND RELEASED FOR CONSTRUCTION                   |             |                  | CHECKED BY _____  |
|  | DATE: ..... | DRAWN BY STANTEC | DATE 05/17/2021   |
|  | DATE: ..... |                  |   |

# SOOS CREEK HATCHERY

## WATER SUPPLY TREATMENT

### FINE SETTLING POND

#### Mechanical Plan and Sections


**DISCIPLINE SHEET #**

---

**PROJECT NO.**

XX:X##:####-#

SHEET OF  
53 74

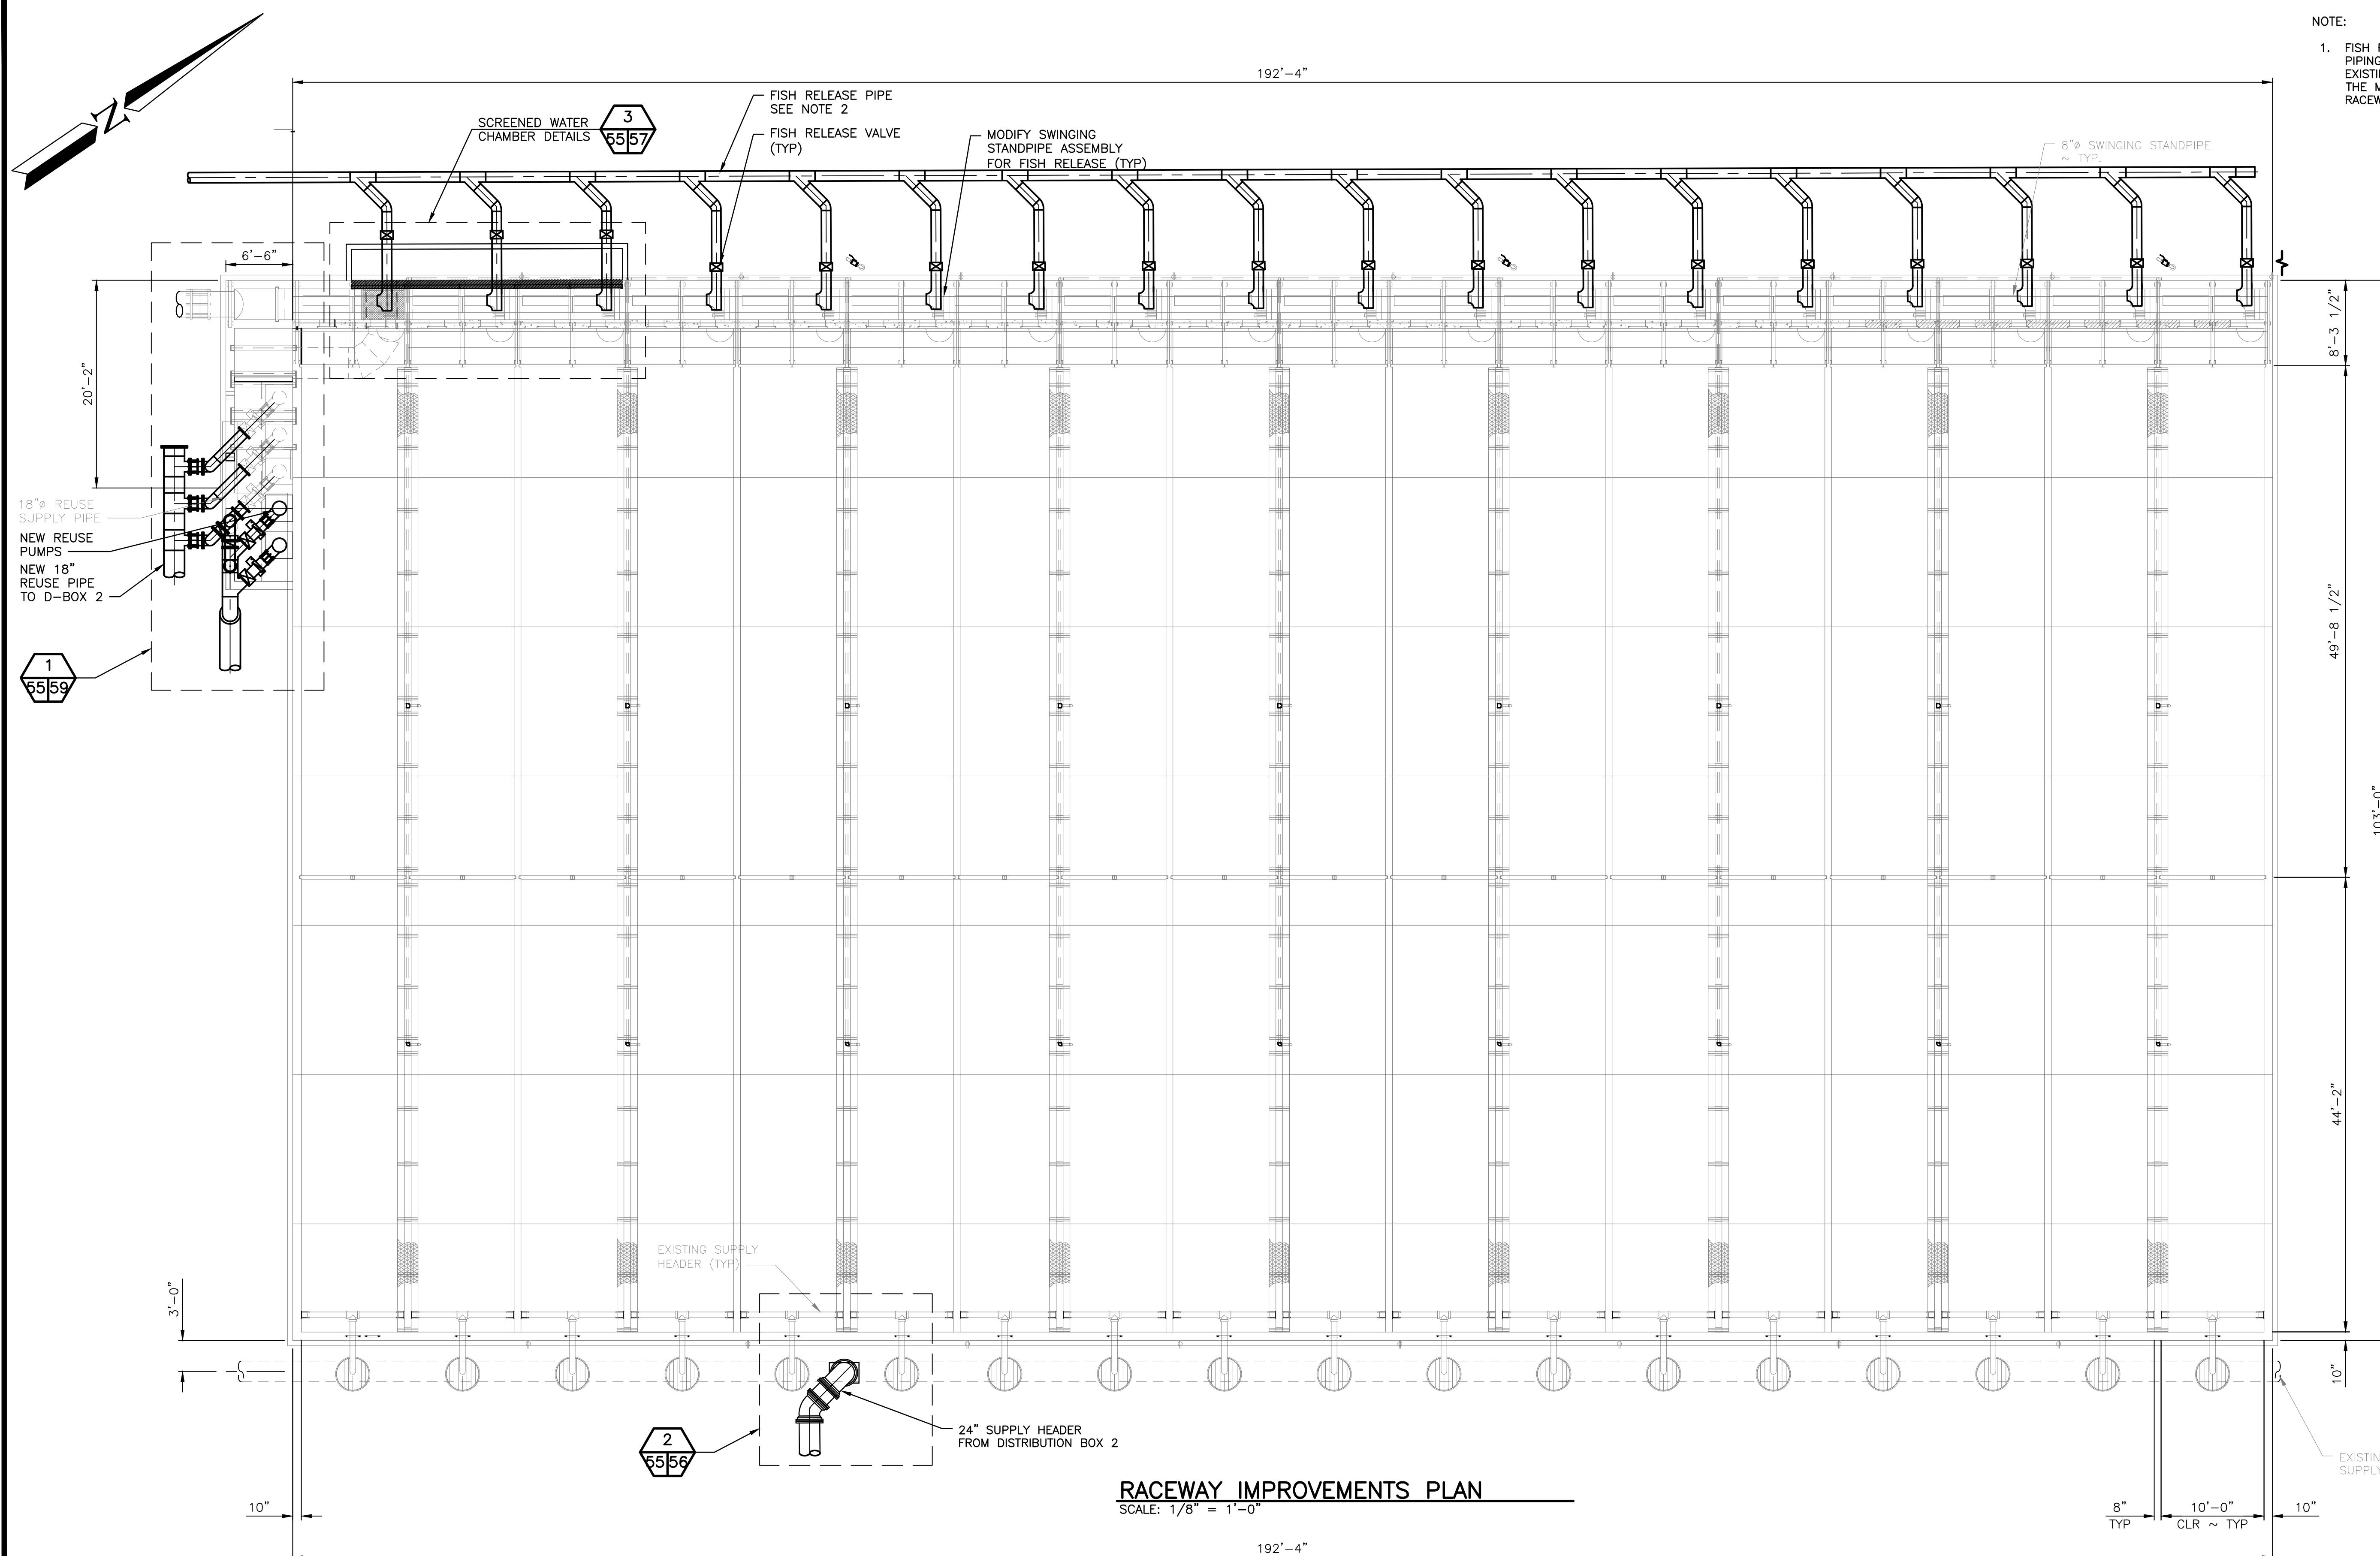

## NOTE.

1. FISH RELEASE PIPE TO CONSIST OF HDPE PIPING AND VALVES CONNECTING BETWEEN THE EXISTING SWINGING STANDPIPE ASSEMBLIES AND THE MAIN DRAIN LOCATED WEST OF THE RACEWAYS. SEE SHEET 15.5 FOR DETAILS.

# RACEWAY IMPROVEMENTS PLAN

SCALE: 1/8" = 1'-0"

192'-4

0 ————— 1"

**BAR MEASURES  
ONE INCH ON  
22x34 DRAWINGS**

# SOOS CREEK HATCHERY

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## WATER SUPPLY TREATMENT

## RACEWAY IMPROVEMENTS PLAN


# DISCIPLINE SHEET #

# M15.1

**PROJECT NO.**



XX:X##:####-#

SHEET OF  
55 74

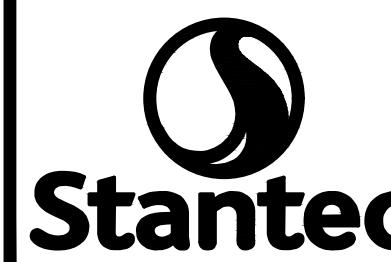

*WASHINGTON DEPARTMENT OF  
FISH & WILDLIFE*

NOTE:  
1. FISH RELEASE PIPE TO CONSIST OF HDPE  
PIPING AND VALVES CONNECTING BETWEEN THE  
EXISTING SWINGING STANDPIPE ASSEMBLIES AND  
THE MAIN DRAIN LOCATED WEST OF THE  
RACEWAYS. SEE SHEET 15.5 FOR DETAILS.

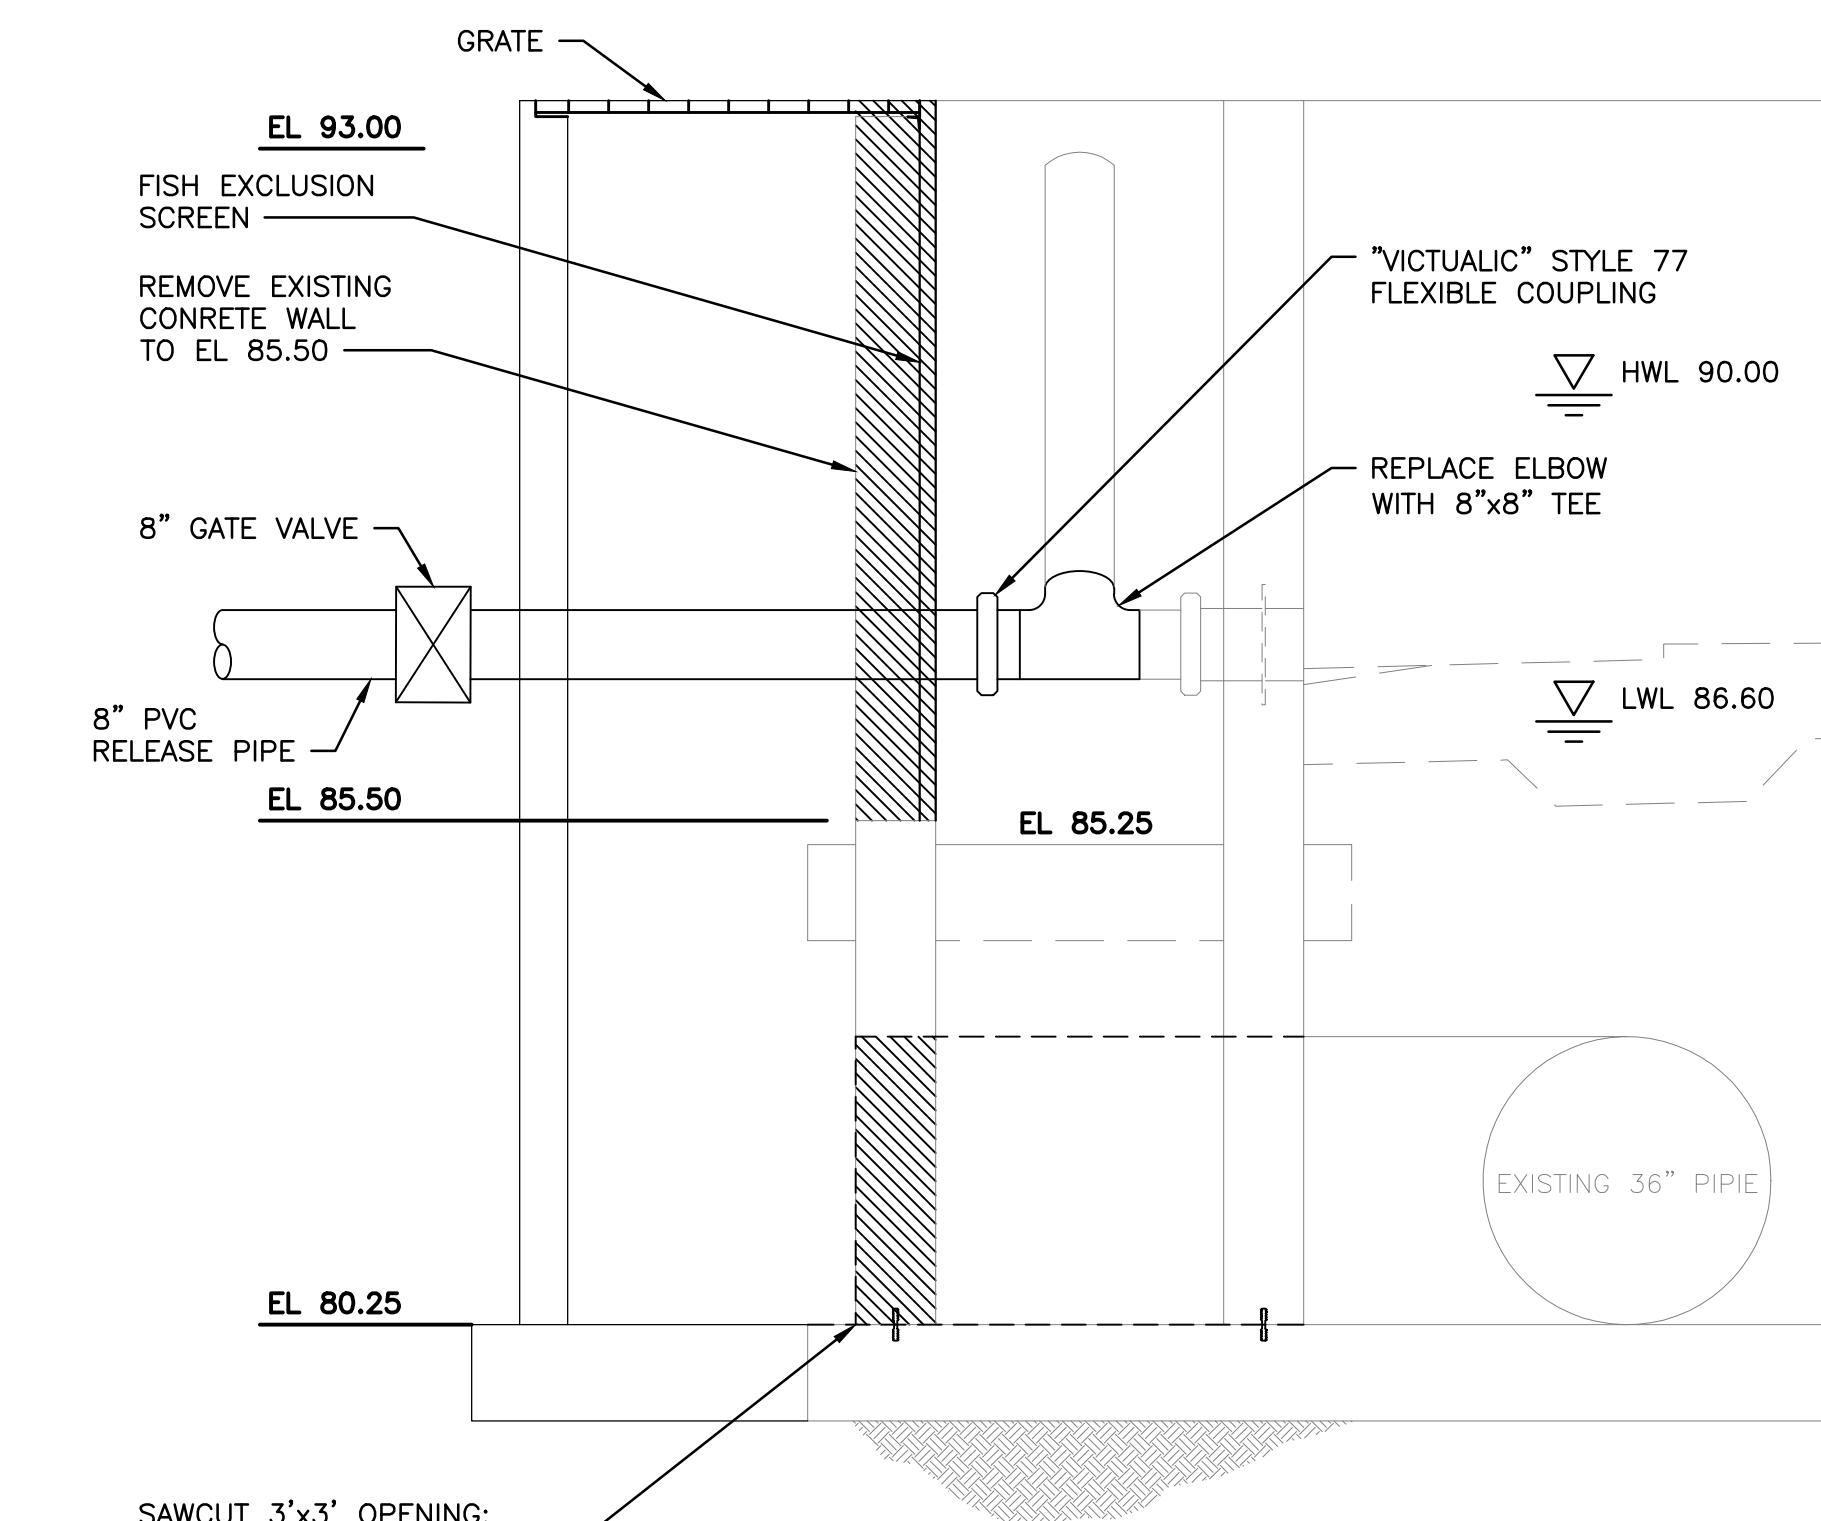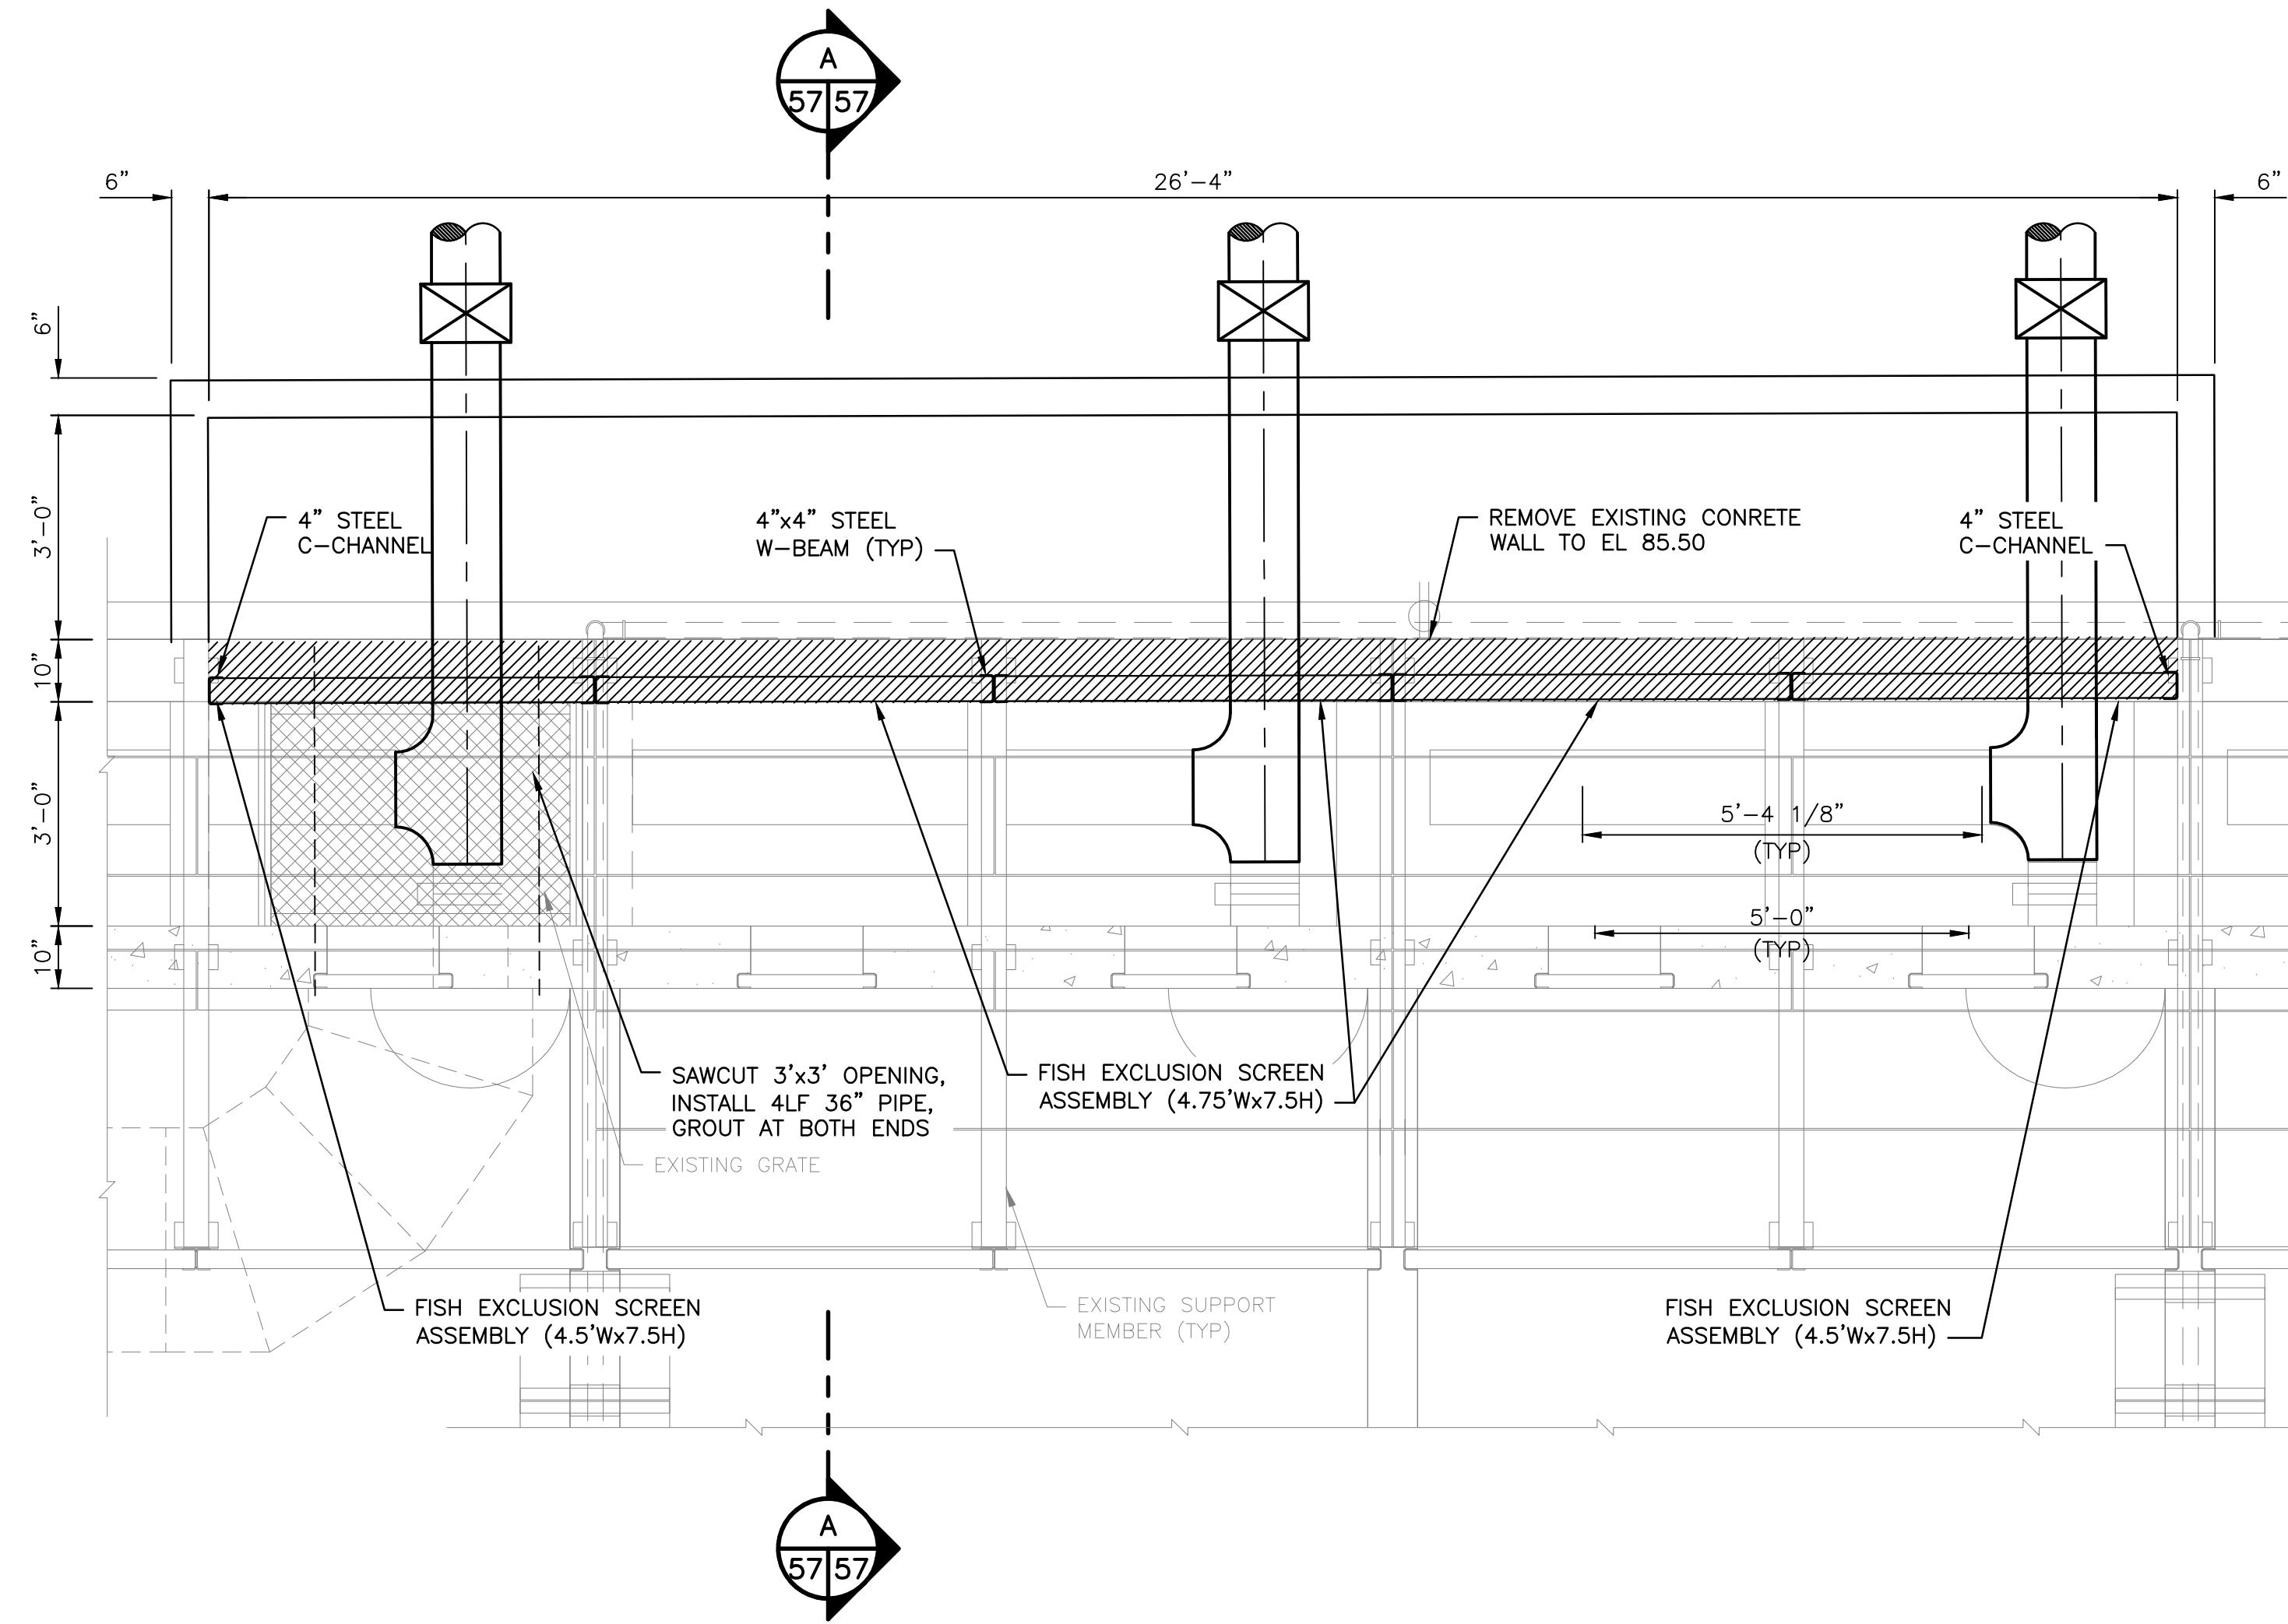

**WASHINGTON DEPARTMENT OF  
FISH & WILDLIFE**

SCHEMATIC DESIGN  
NOT FOR CONSTRUCTION  
MAY 17, 2021

SYM DATE REVISION DESCRIPTION BY  
APPROVED AND RELEASED FOR CONSTRUCTION

CHIEF ENGINEER ..... DATE: .....  
PROGRAM ..... DATE: .....

0 \_\_\_\_\_ 1"  
BAR MEASURES  
ONE INCH ON  
22x34 DRAWINGS

DESIGNED BY D. WHITBECK

CHECKED BY

DRAWN BY STANTEC


DATE 05/17/2021

**SOOS CREEK HATCHERY**  
**WATER SUPPLY TREATMENT**  
**SCREENED WATER CHAMBER**  
**PLAN AND SECTION**

DISCIPLINE SHEET #  
**M15.3**


PROJECT NO.  
**XX:X##:###-#**

SHEET **57** OF **74**

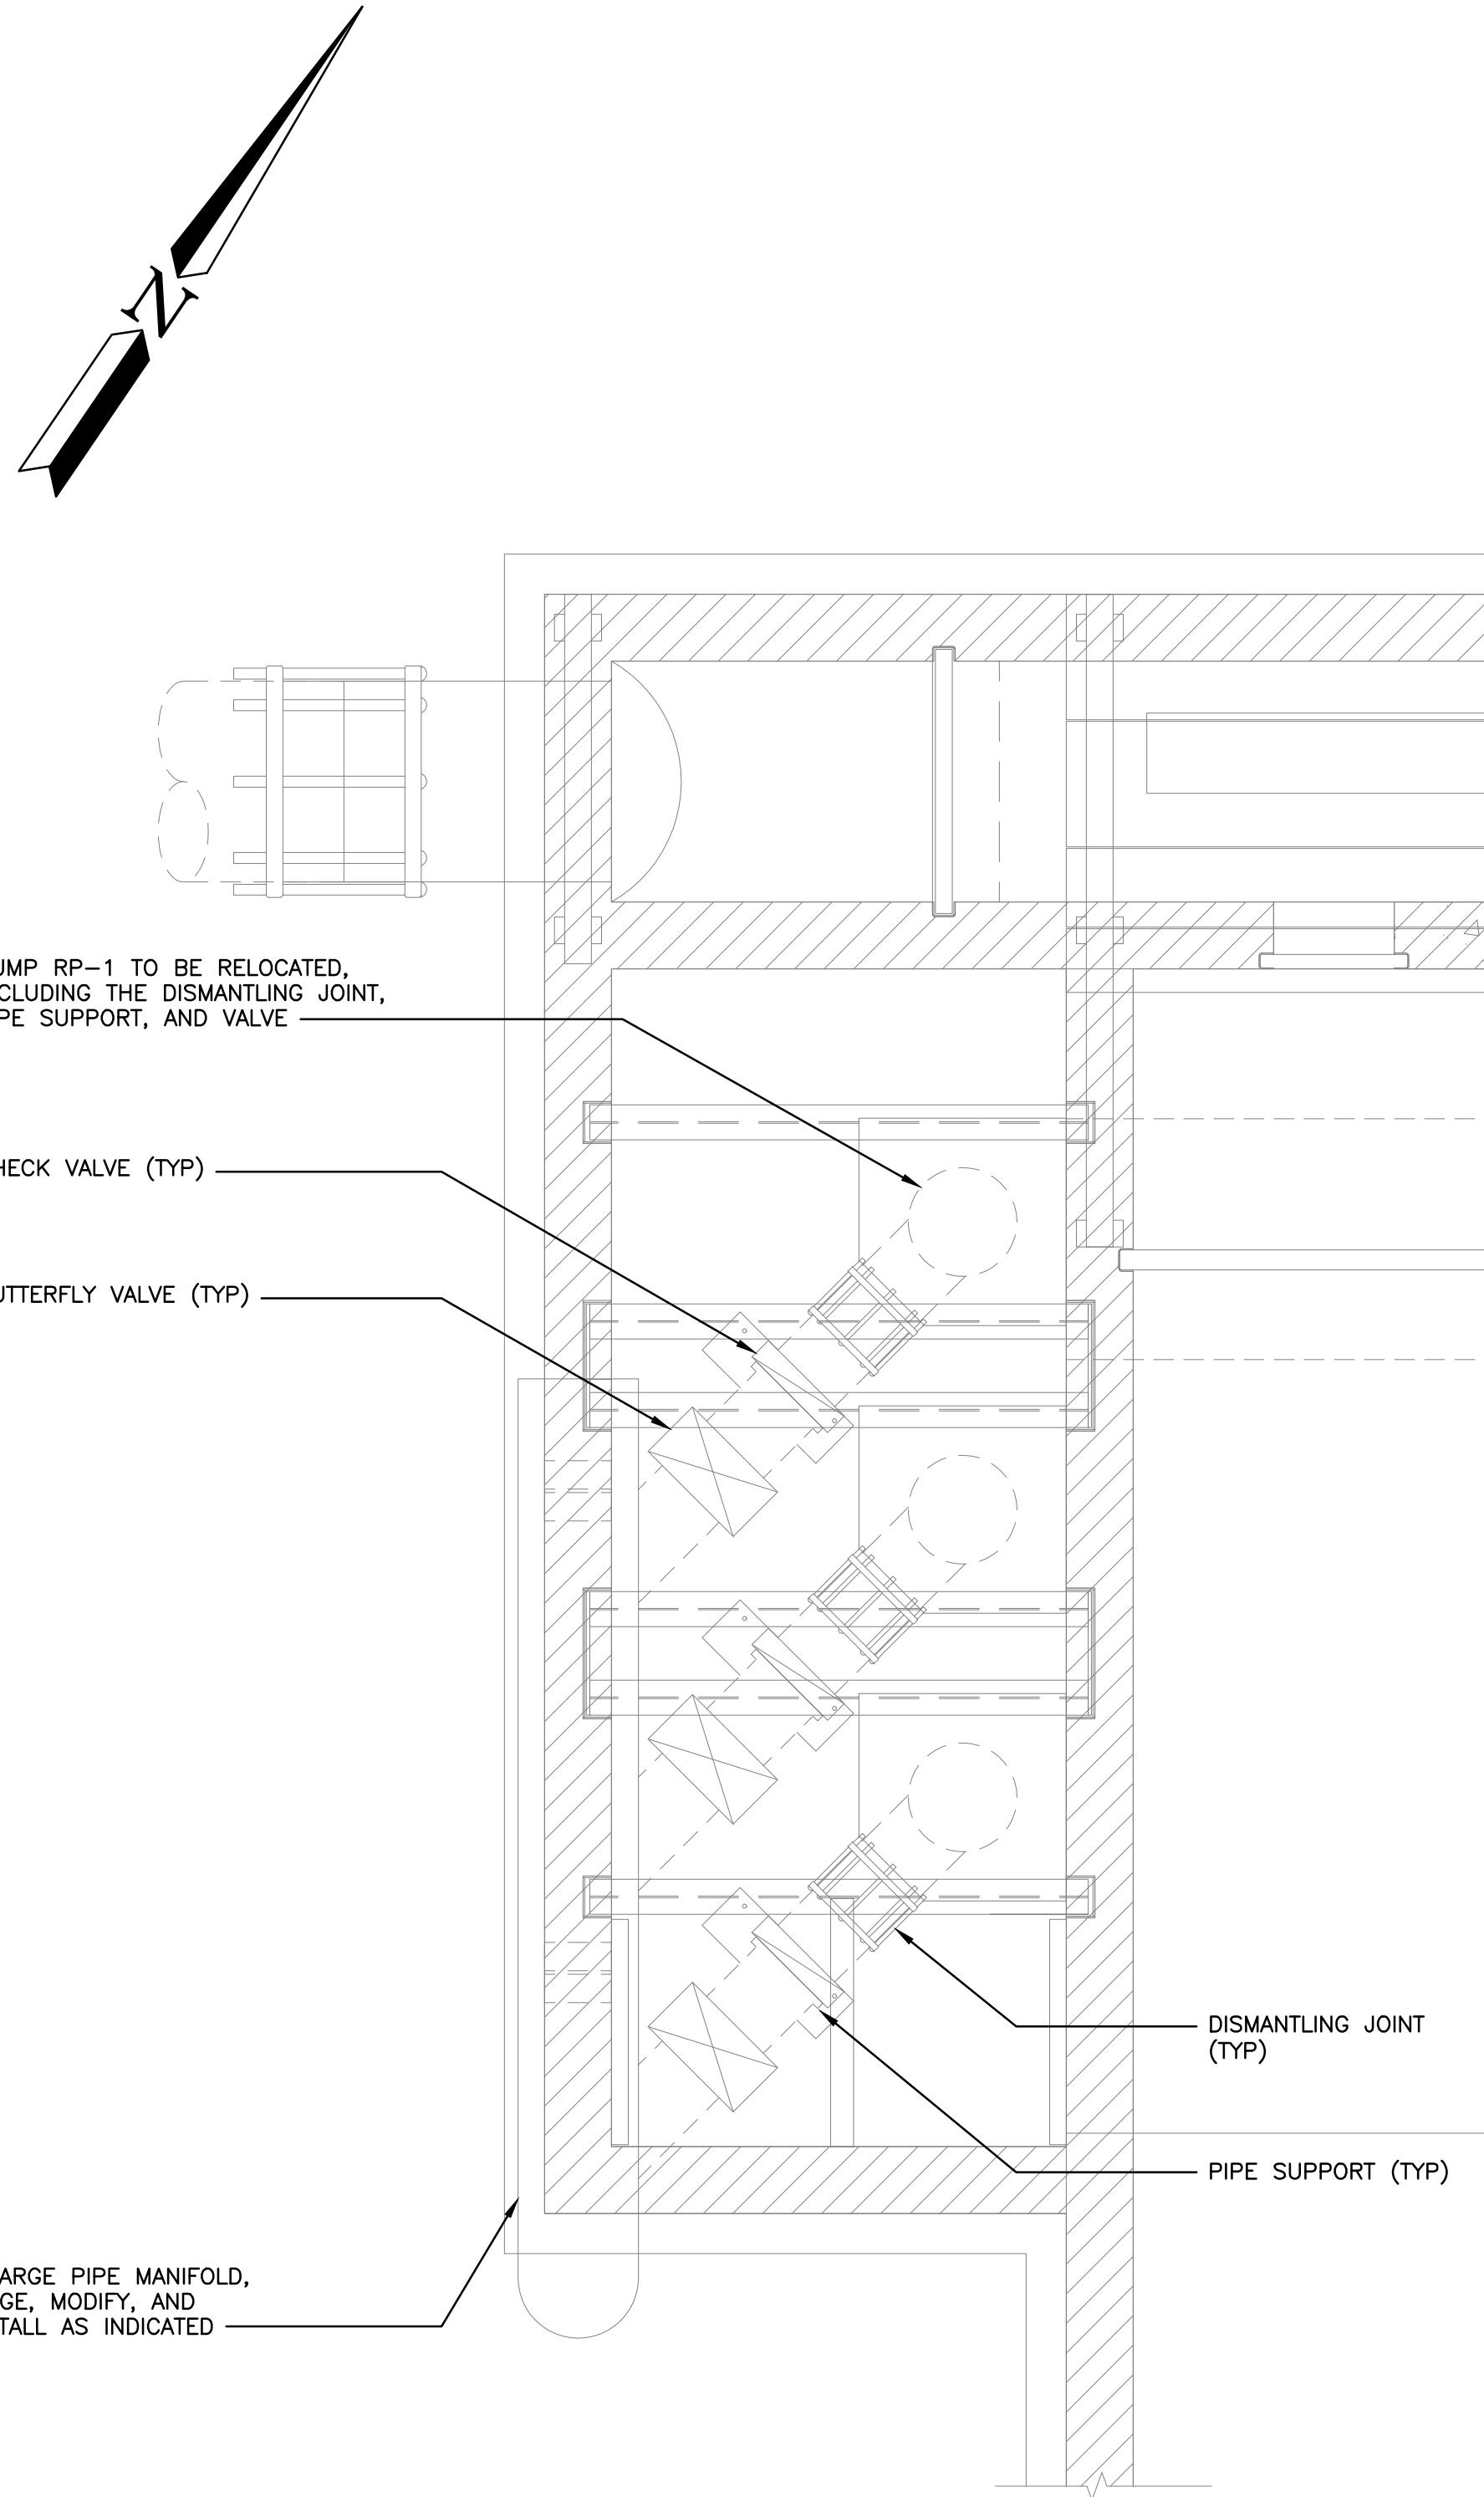

**EXISTING REUSE BOX PLAN**

SCALE: 1/2" = 1'-0"

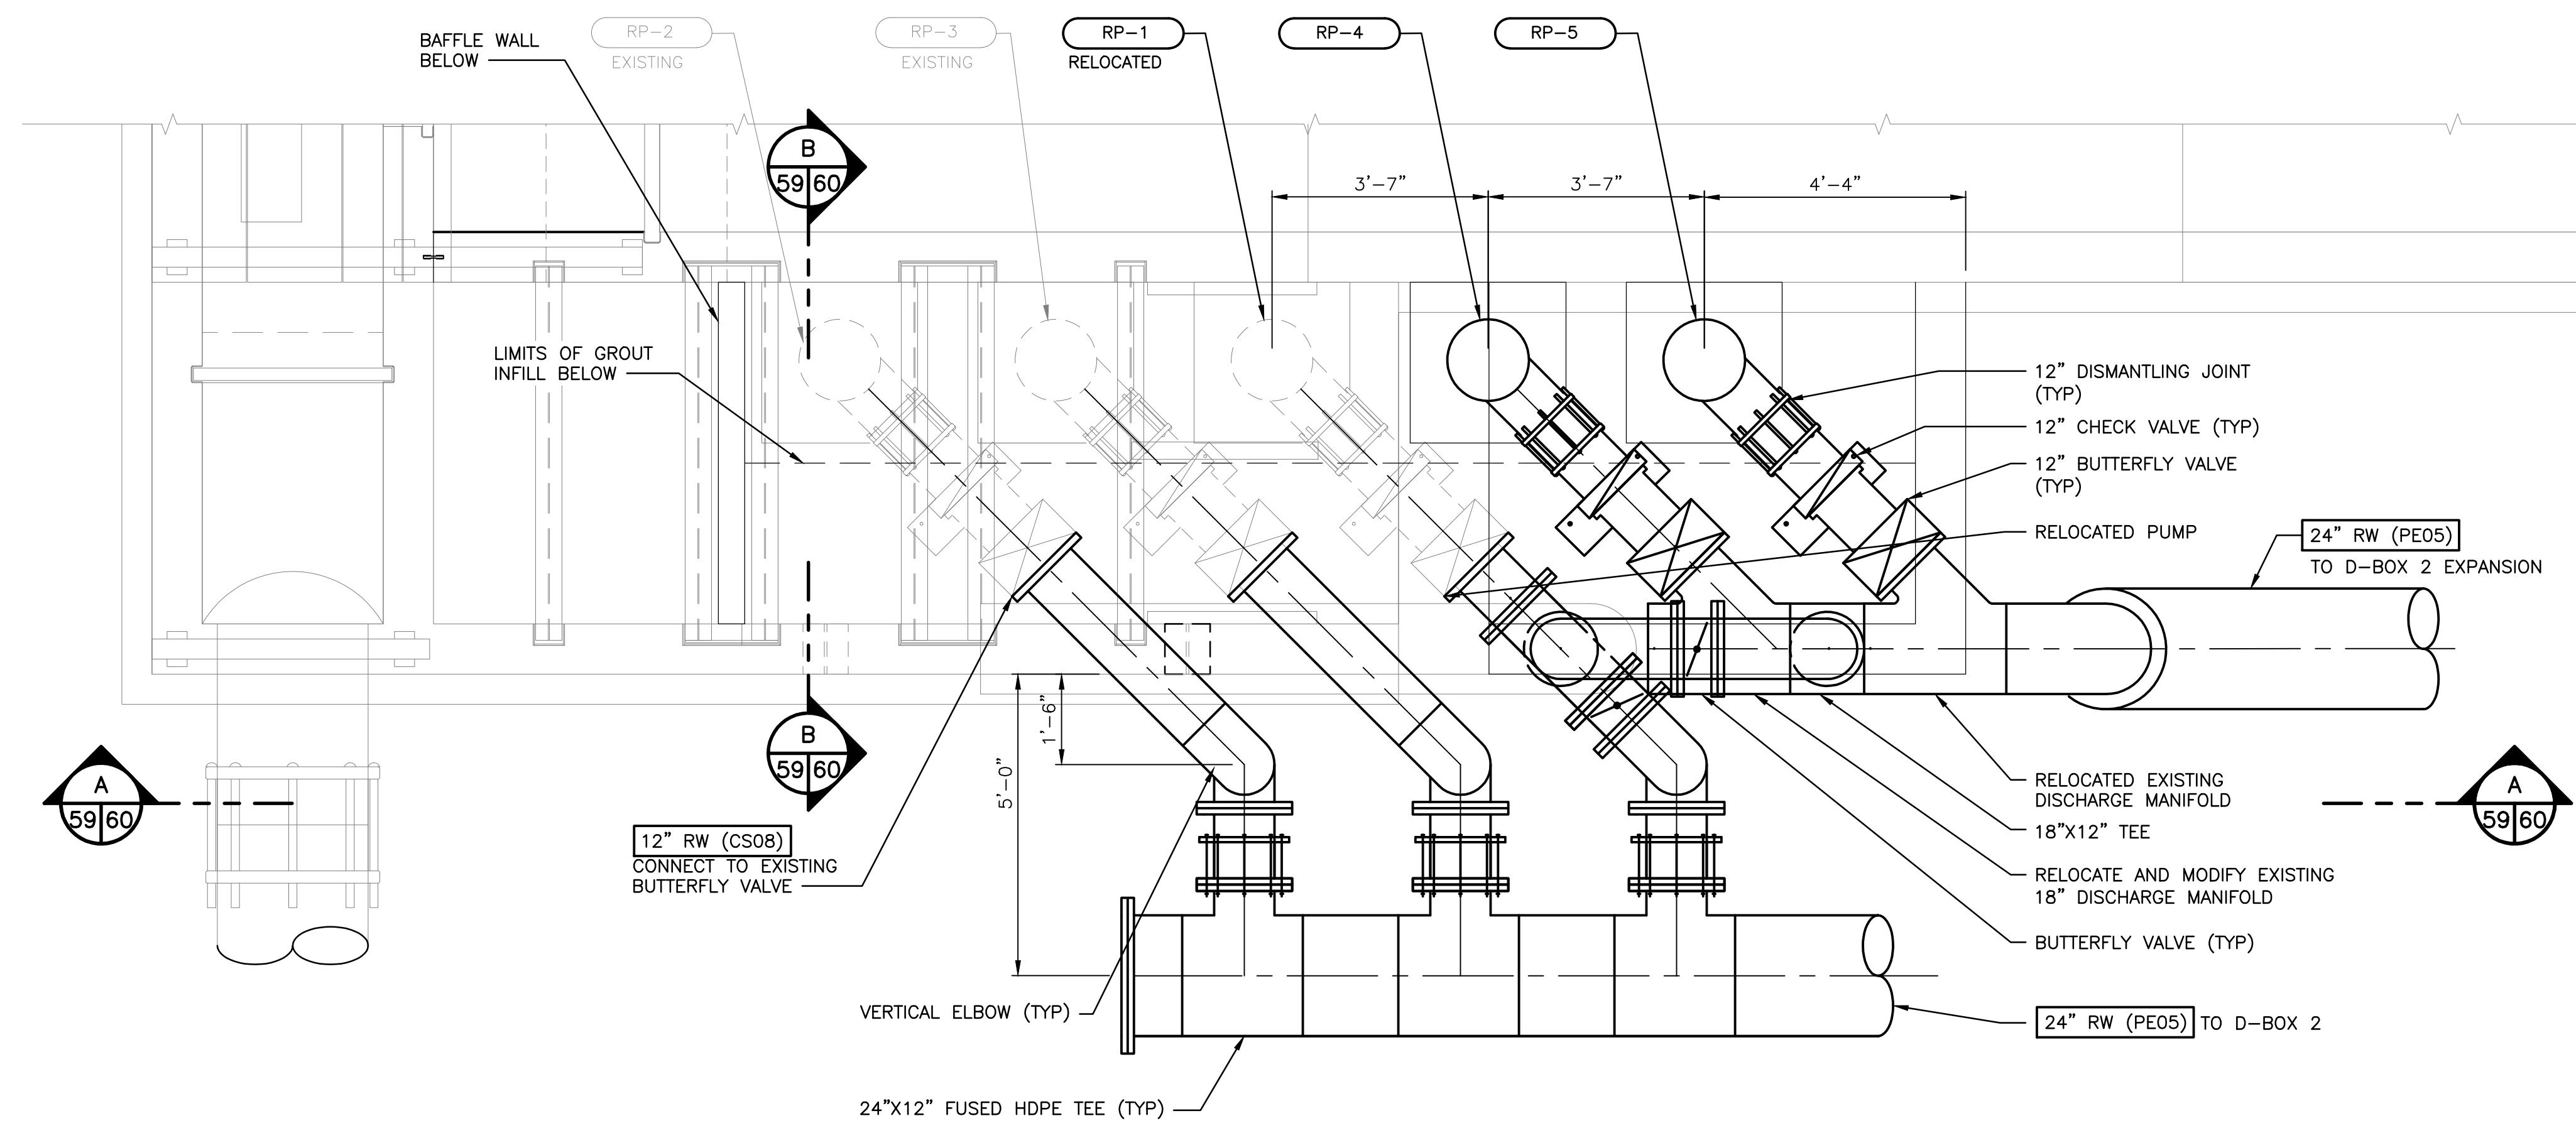

**REUSE BOX EXPANSION PLAN**

SCALE: 1/2" = 1'-0"



**WASHINGTON DEPARTMENT OF  
FISH & WILDLIFE**



|                           |      | SCHEMATIC DESIGN<br>NOT FOR CONSTRUCTION<br>MAY 17, 2021 |  | 0 ————— 1"<br>BAR MEASURES<br>ONE INCH ON<br>22x34 DRAWINGS |                         |
|---------------------------|------|--|--|---|-------------------------|
| SYM                       | DATE | REVISION DESCRIPTION                                     |  | BY  | DESIGNED BY D. WHITBECK |
|                           |      | APPROVED AND RELEASED FOR CONSTRUCTION                   |  |   | CHECKED BY _____        |
| CHIEF ENGINEER<br>PROGRAM |      |  |  | DRAWN BY STANTEC  | DATE 05/17/2021         |

**SOOS CREEK HATCHERY  
WATER SUPPLY TREATMENT  
REUSE BOX EXPANSION  
PLAN**


DISCIPLINE SHEET #  
**M15.5**

PROJECT NO.  
**XX:X##:###-#**

SHEET **59** OF **74**

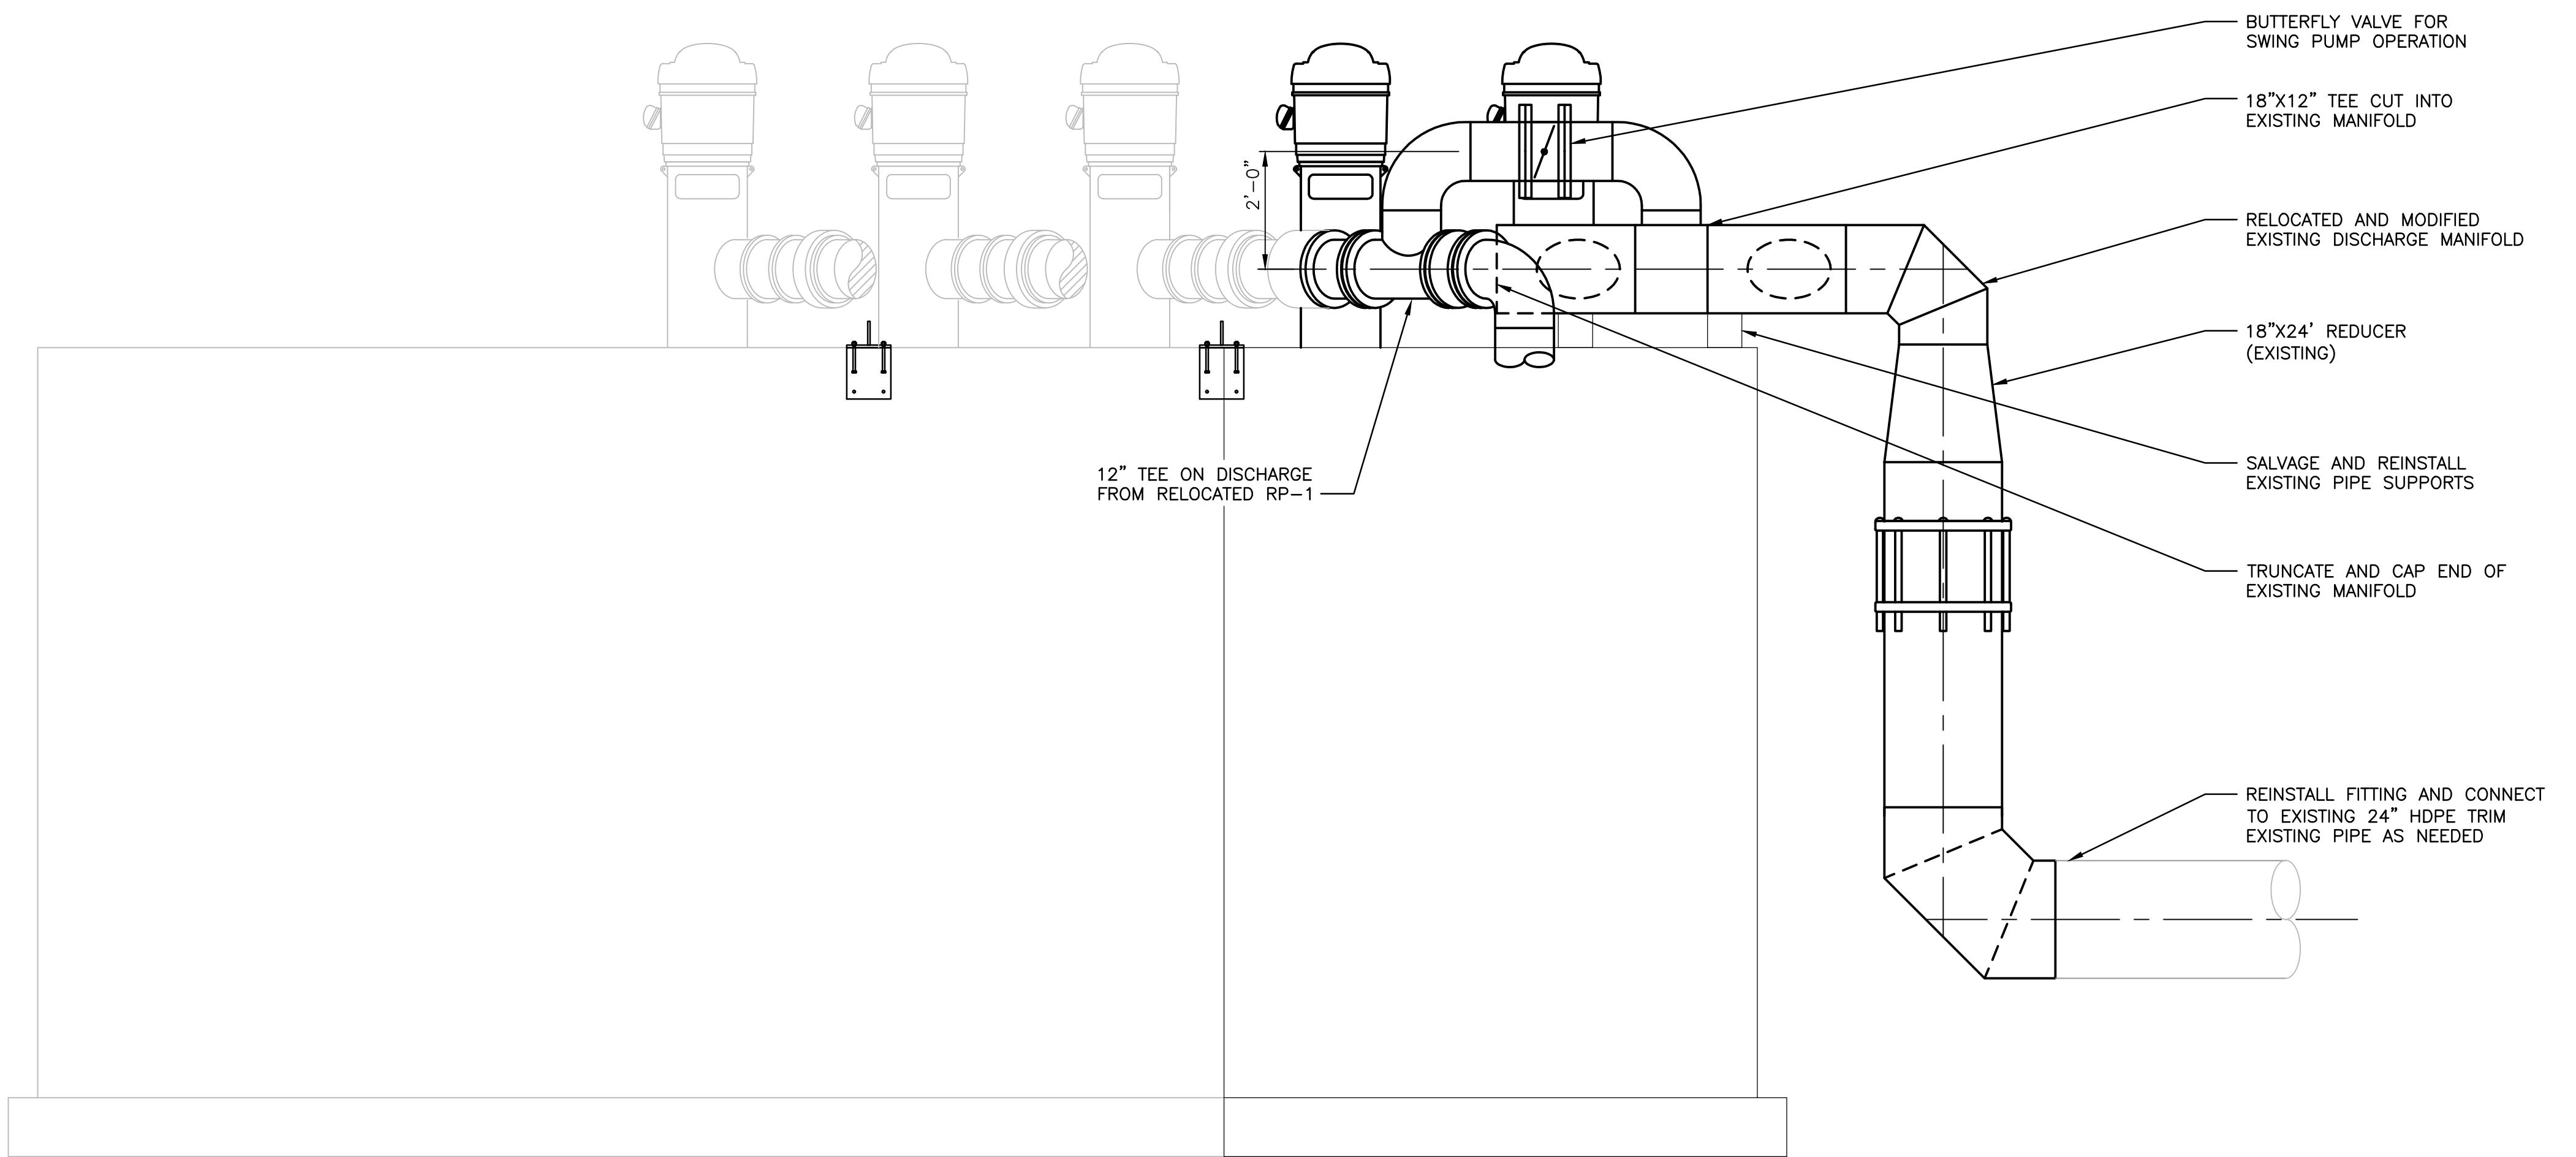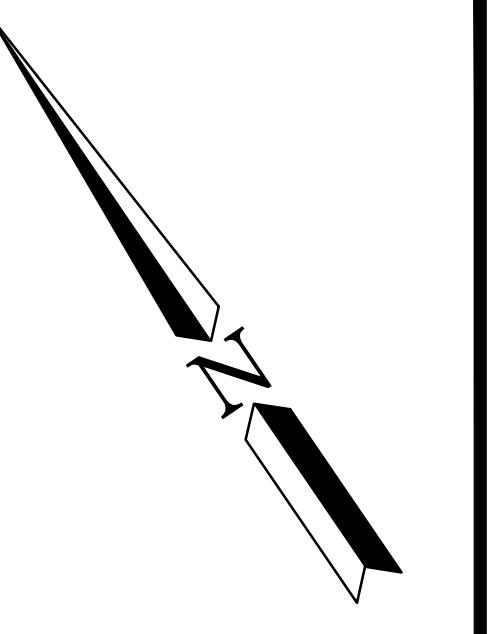

SECTION A  
SCALE: 1/2" = 1'-0" 59|60

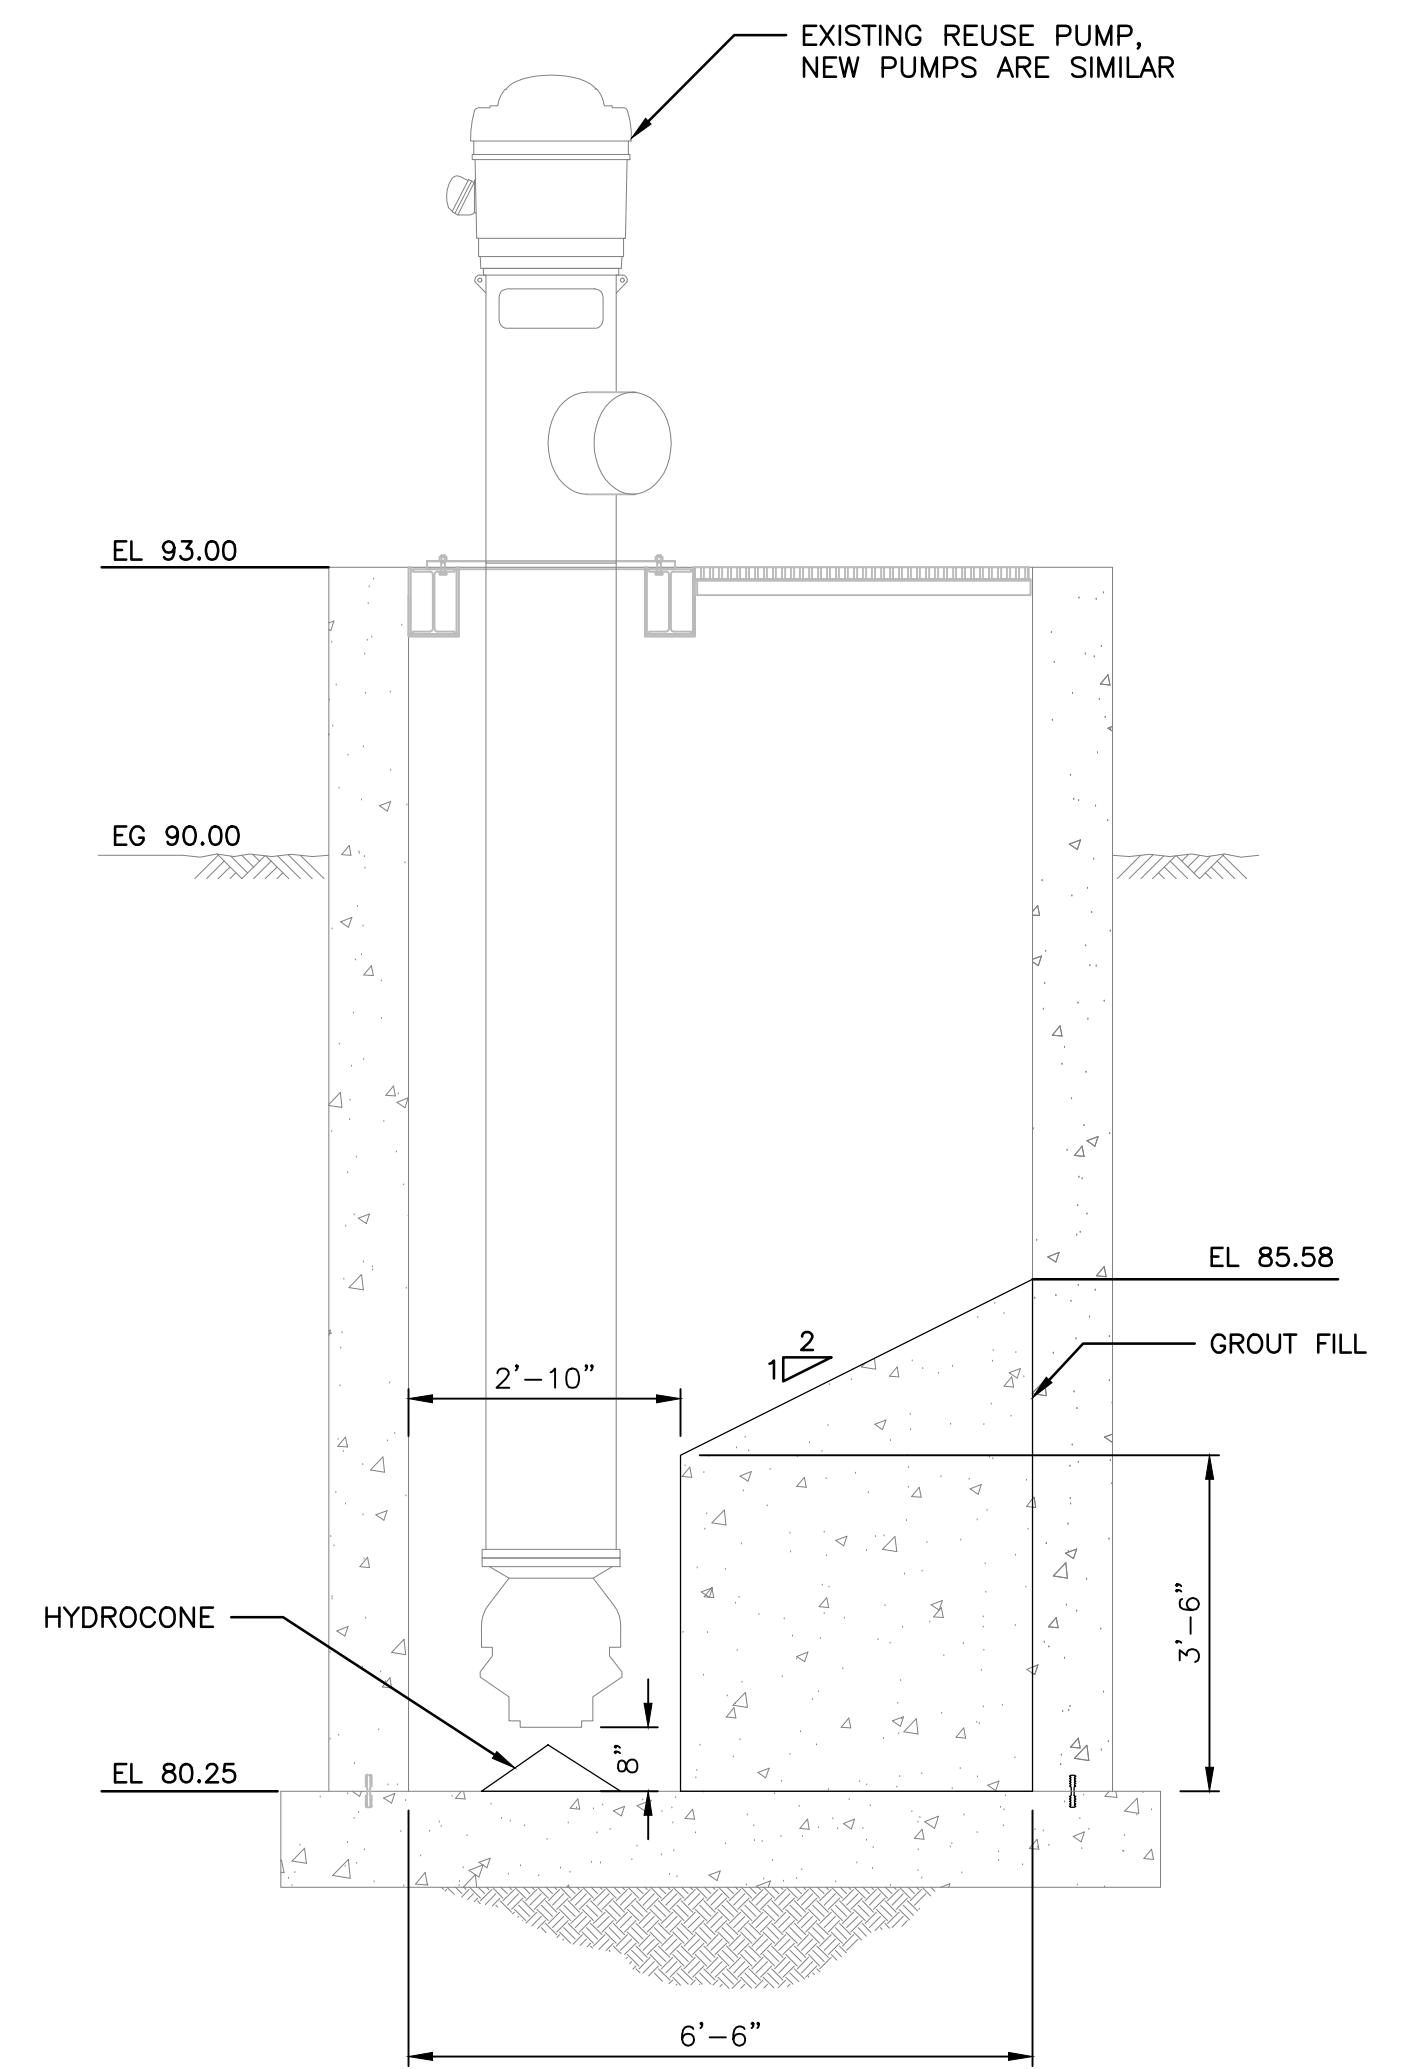

SECTION B  
SCALE: 1/2" = 1'-0" 59|60





WASHINGTON DEPARTMENT OF  
FISH & WILDLIFE

|                           |      | SCHEMATIC DESIGN<br>NOT FOR CONSTRUCTION<br>MAY 10, 2021 |  | 0 ————— 1"<br>BAR MEASURES<br>ONE INCH ON<br>22x34 DRAWINGS |                         |
|---------------------------|------|--|--|---|-------------------------|
| SYM                       | DATE | REVISION DESCRIPTION                                     |  | BY  | DESIGNED BY D. WHITBECK |
|                           |      | APPROVED AND RELEASED FOR CONSTRUCTION                   |  |   | CHECKED BY _____        |
| CHIEF ENGINEER<br>PROGRAM |      | DATE:  |  | DRAWN BY STANTEC  | DATE 05/17/2021         |

SOOS CREEK HATCHERY  
WATER SUPPLY TREATMENT  
REUSE BOX EXPANSION  
SECTIONS

DISCIPLINE SHEET #  
**M15.6**

PROJECT NO.  
XX:X##:###-#  
SHEET 60 OF 74

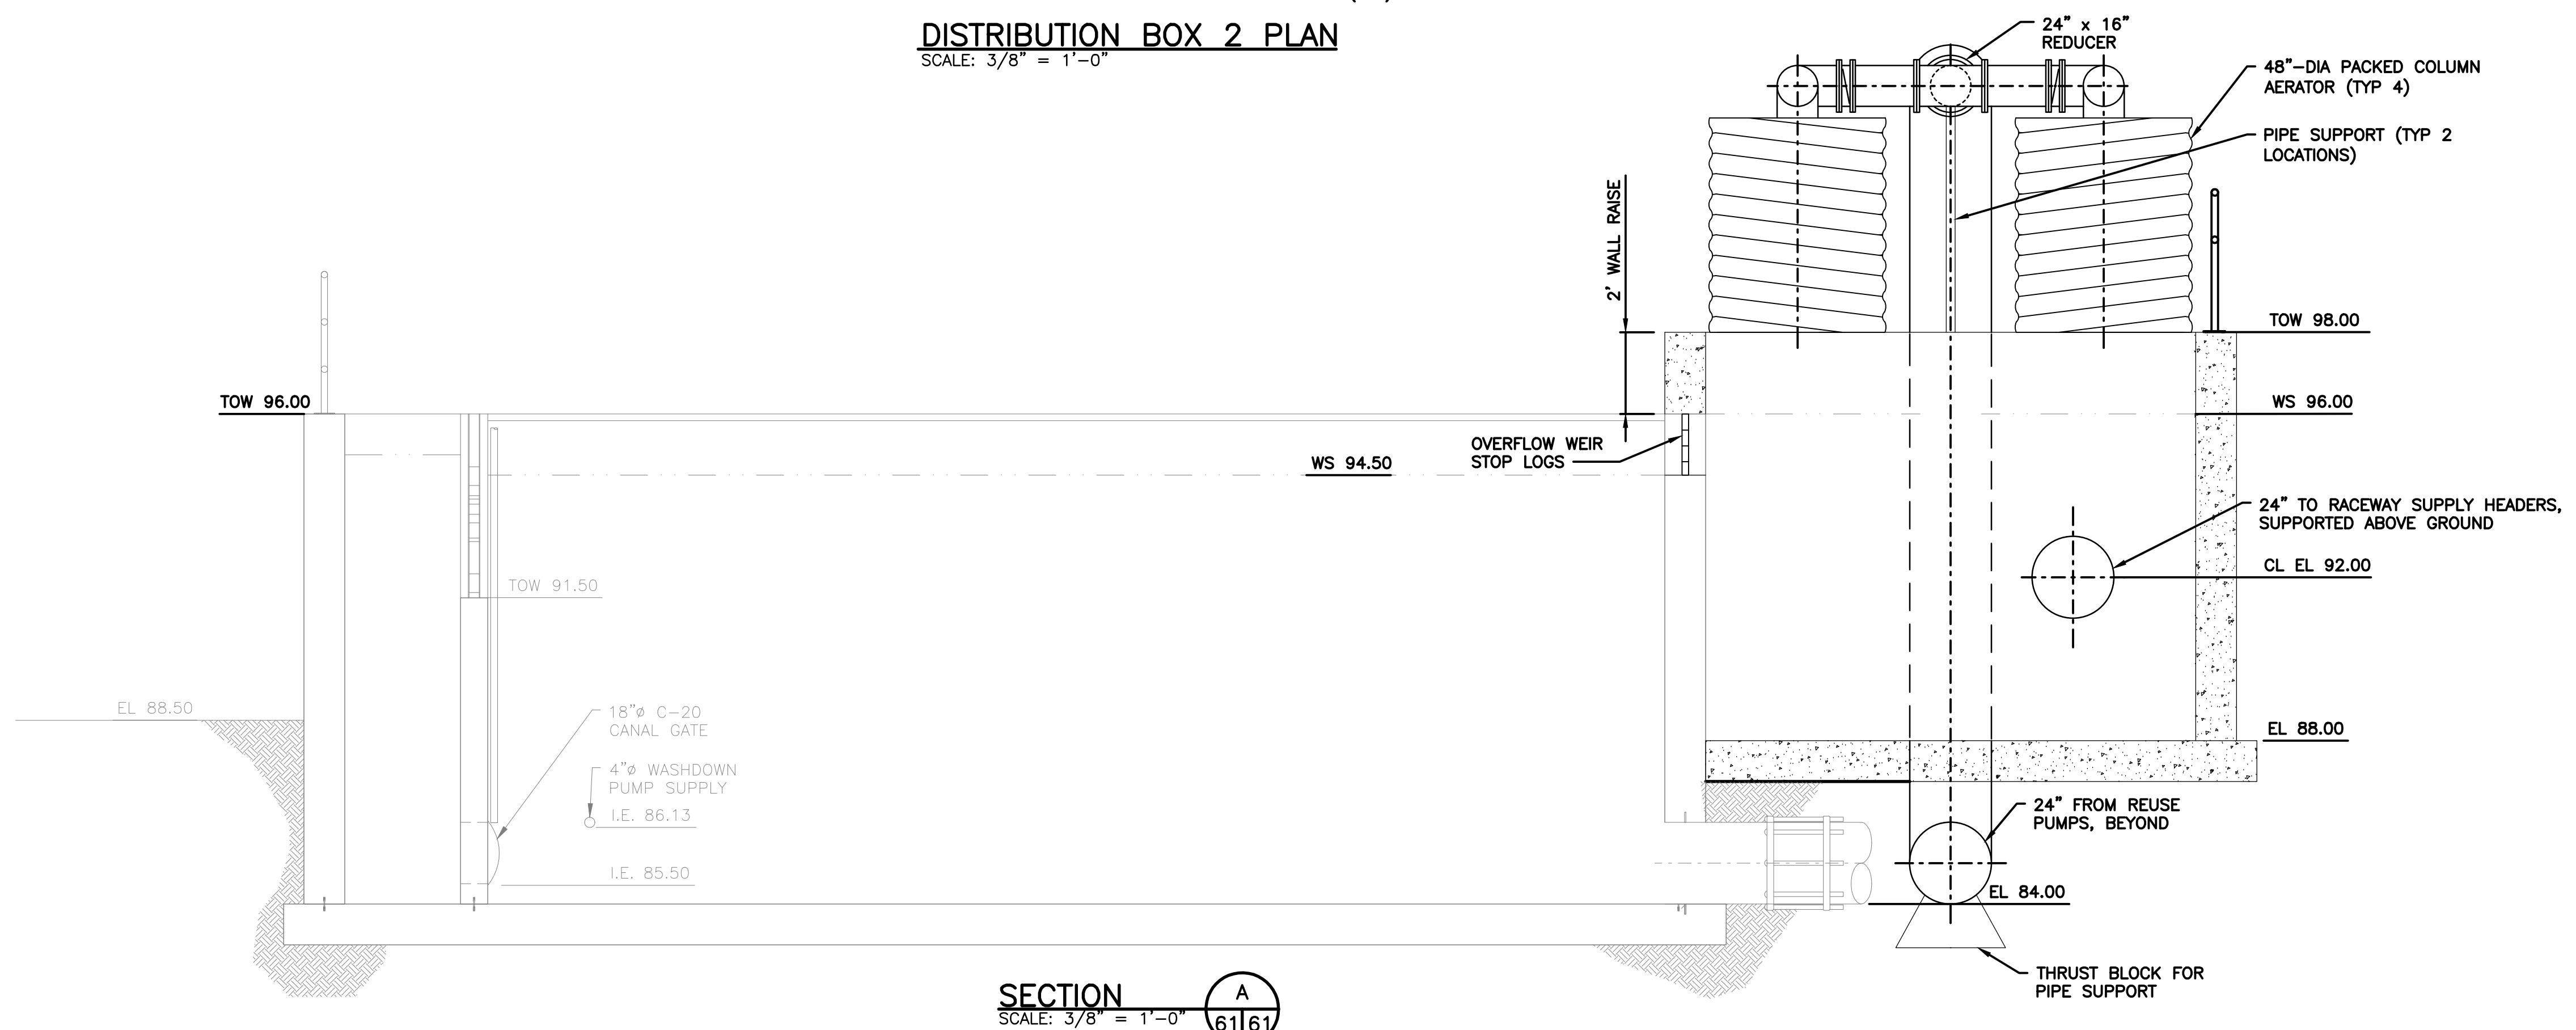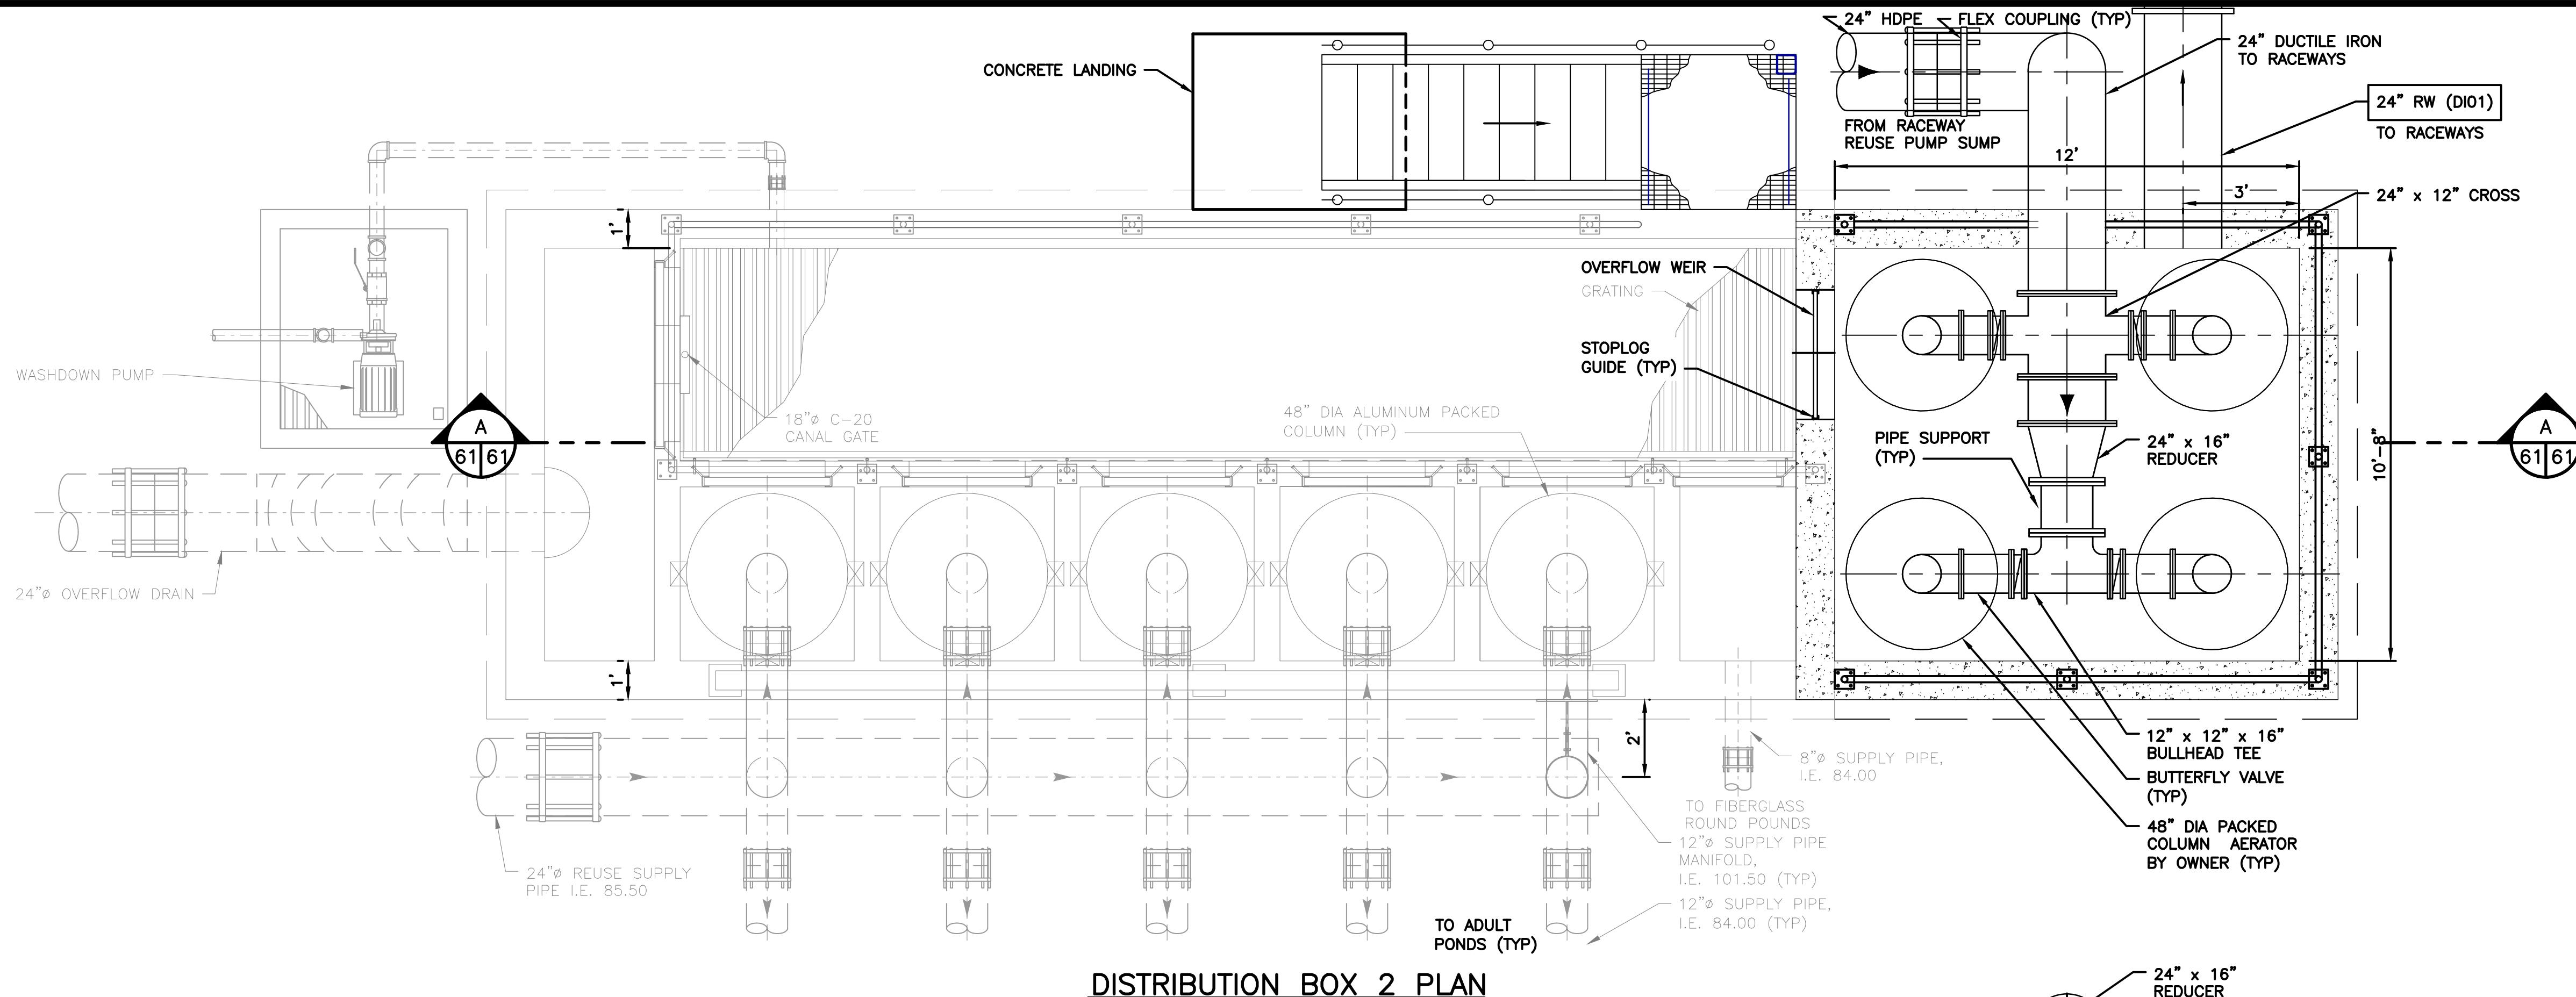

WASHINGTON DEPARTMENT OF  
FISH & WILDLIFE

SCHEMATIC DESIGN  
NOT FOR CONSTRUCTION  
MAY 17, 2021

APPROVED AND RELEASED FOR CONSTRUCTION

CHIEF ENGINEER ..... DATE: .....  
PROGRAM ..... DATE: .....

0 ————— 1"  
BAR MEASURES  
ONE INCH ON  
22x34 DRAWINGS

DESIGNED BY F. LAST

CHECKED BY F. LAST

DRAWN BY S. NADKAR

DATE MM/DD/YYYY

SOOS CREEK HATCHERY  
WATER SUPPLY TREATMENT  
DISTRIBUTION BOX 2  
EXPANSION PLAN

DISCIPLINE SHEET #  
**M16.1**

PROJECT NO.  
XX:X##:###-#

SHEET 61 OF 74

